

PERMIT SITE PLAN

for

BRUSH HILL HOMES

GENERAL NOTES


1. ELEVATIONS SHOWN HEREON REFER TO NAVD88.
2. PROPERTY LINE AND TOPOGRAPHIC INFORMATION SHOWN HEREON IS FROM DGT ASSOCIATES.
3. THE CONTRACTOR SHALL VERIFY THE LOCATION AND RELATIVE ELEVATION OF BENCHMARKS PRIOR TO THE COMMENCEMENT OF ANY CONSTRUCTION. ANY DISCREPANCY SHALL BE REPORTED TO THE ENGINEER.
4. ALL SITE CONSTRUCTION SHALL COMPLY WITH THE TOWN OF SHERBORN DEPARTMENT OF PUBLIC WORKS.
5. IN CASES WHERE LEDGE, BURIED FOUNDATIONS OR BOULDERS ARE PRESENT, DGT ASSOCIATES SHALL NOT BE RESPONSIBLE FOR THE AMOUNT OF ROCK OR CONCRETE ENCOUNTERED.
6. DGT ASSOCIATES SHALL BE NOTIFIED OF ANY SIGNIFICANT DIFFERENCES IN THE EXISTING CONDITIONS OR UTILITIES THAT MAY AFFECT THE CONSTRUCTION SHOWN ON THIS PLAN FOR ANY NECESSARY PLAN REVISIONS.
7. THIS PLAN IS NOT INTENDED TO SHOW AN ENGINEERED BUILDING FOUNDATION DESIGN WHICH WOULD INCLUDE DETAILS AND ELEVATIONS FOR FOOTINGS, FOUNDATION WALL DESIGN AND ANY SUBSURFACE DRAINAGE TO PREVENT FLOODING. COORDINATE WITH THE ARCHITECTURAL AND STRUCTURAL PLANS.
8. THE PROPOSED BUILDING CONFIGURATION AS SHOWN HEREON SHALL BE CONSIDERED CONCEPTUAL AND SHALL BE VERIFIED WITH THE FINAL ARCHITECTURAL PLANS AND THE CURRENT ZONING ORDINANCES PRIOR TO CONSTRUCTION.
9. THE CONTRACTOR SHALL BE RESPONSIBLE FOR THE REPAIR AND/OR REPLACEMENT OF ANY EXISTING FEATURES DAMAGED DURING CONSTRUCTION THAT ARE NOT INTENDED FOR DEMOLITION AND/OR REMOVAL HEREON.
10. SAFETY MEASURES, CONSTRUCTION METHODS AND CONTROL OF WORK SHALL BE THE RESPONSIBILITY OF THE CONTRACTOR.

GRADING AND UTILITY PLAN NOTES

1. LOCATIONS OF EXISTING UNDERGROUND UTILITIES SHOWN HEREON ARE APPROXIMATE ONLY. ALL UTILITIES, OBSTRUCTIONS AND/OR SYSTEMS MAY NOT BE SHOWN. IT SHALL BE THE RESPONSIBILITY OF THE CONTRACTOR FOR LOCATING AND PROTECTING ALL EXISTING UNDERGROUND UTILITIES AND/OR SYSTEMS WHETHER OR NOT SHOWN HEREON.
2. UNLESS OTHERWISE SHOWN HEREON, ALL NEW UTILITIES SHALL BE UNDERGROUND.
3. RIM ELEVATIONS SHOWN HEREON FOR NEW STRUCTURES ARE PROVIDED TO ASSIST THE CONTRACTOR WITH MATERIAL TAKEOFFS. FINAL RIM ELEVATIONS SHALL MATCH PAVEMENT, GRADING, LANDSCAPING, UNLESS SPECIFICALLY INDICATED OTHERWISE.
4. WHERE CONNECTIONS AND STRUCTURES ARE TO BE INSTALLED AT EXISTING UTILITIES, THE CONTRACTOR SHALL CONFIRM THE LOCATION AND ELEVATION PRIOR TO INSTALLATION AND SHALL REPORT ANY SIGNIFICANT DISCREPANCY FROM THE PLAN INFORMATION TO THE ENGINEER.
5. CURB RADII AND DIMENSIONS SHOWN HEREON ARE AT THE FACE OF CURB.
6. WHERE NEW PAVING MEETS EXISTING PAVING, MEET LINE AND GRADE OF EXISTING.
7. AT LOCATIONS WHERE EXISTING PAVEMENT ABUTS NEW CONSTRUCTION, THE EDGE OF THE EXISTING PAVEMENT SHALL BE SAWCUT TO A CLEAN AND SMOOTH EDGE.
8. PERIMETER EROSION CONTROLS SHOWN HEREON SHALL BE INSTALLED PRIOR TO ANY EARTH DISTURBANCE AND SHALL SERVE AS A LIMIT OF WORK, UNLESS OTHERWISE SHOWN.
9. THE CONTRACTOR SHALL PROVIDE DUST CONTROL FOR CONSTRUCTION OPERATIONS AS APPROVED BY THE ENGINEER.
10. ALL POINTS OF CONSTRUCTION EGRESS OR INGRESS SHALL BE MAINTAINED TO PREVENT THE TRACKING OR FLOWING OF SEDIMENT ONTO PUBLIC ROADS.

REGULATORY NOTES

1. THE LOCATION OF ALL UNDERGROUND UTILITIES SHOWN HEREON ARE BASED ON FIELD LOCATION OF VISIBLE STRUCTURES AND COMPILED INFORMATION FROM PLANS PROVIDED BY UTILITY COMPANIES AND GOVERNMENT AGENCIES. THE LOCATION SHOWN HEREON SHALL BE CONSIDERED APPROXIMATE. BEFORE ANY CONSTRUCTION, DEMOLITION OR SITE WORK, THE LOCATION OF ALL UNDERGROUND UTILITIES SHALL BE VERIFIED BY THE CONTRACTOR BY CONTACTING "DIG-SAFE" AT 811.
2. THE CONTRACTOR SHALL MAKE HIMSELF AWARE OF ALL CONSTRUCTION REQUIREMENTS, CONDITIONS AND LIMITATIONS IMPOSED BY PERMITS AND APPROVALS ISSUED BY REGULATORY AUTHORITIES PRIOR TO THE COMMENCEMENT OF ANY WORK. CONTRACTOR SHALL COORDINATE AND OBTAIN ALL CONSTRUCTION PERMITS REQUIRED BY REGULATORY AUTHORITIES.
3. ALL WORK OUTSIDE OF THE BUILDING THAT IS LESS THAN 10 FEET FROM THE INSIDE FACE OF THE BUILDING FOUNDATIONS SHALL CONFORM WITH THE UNIFORM STATE PLUMBING CODE OF MASSACHUSETTS, 248 CMR.
4. CONSTRUCTION ACTIVITIES SHALL CONFORM TO THE RULES AND REGULATIONS OF THE OCCUPATIONAL SAFETY AND HEALTH ADMINISTRATION (OSHA).

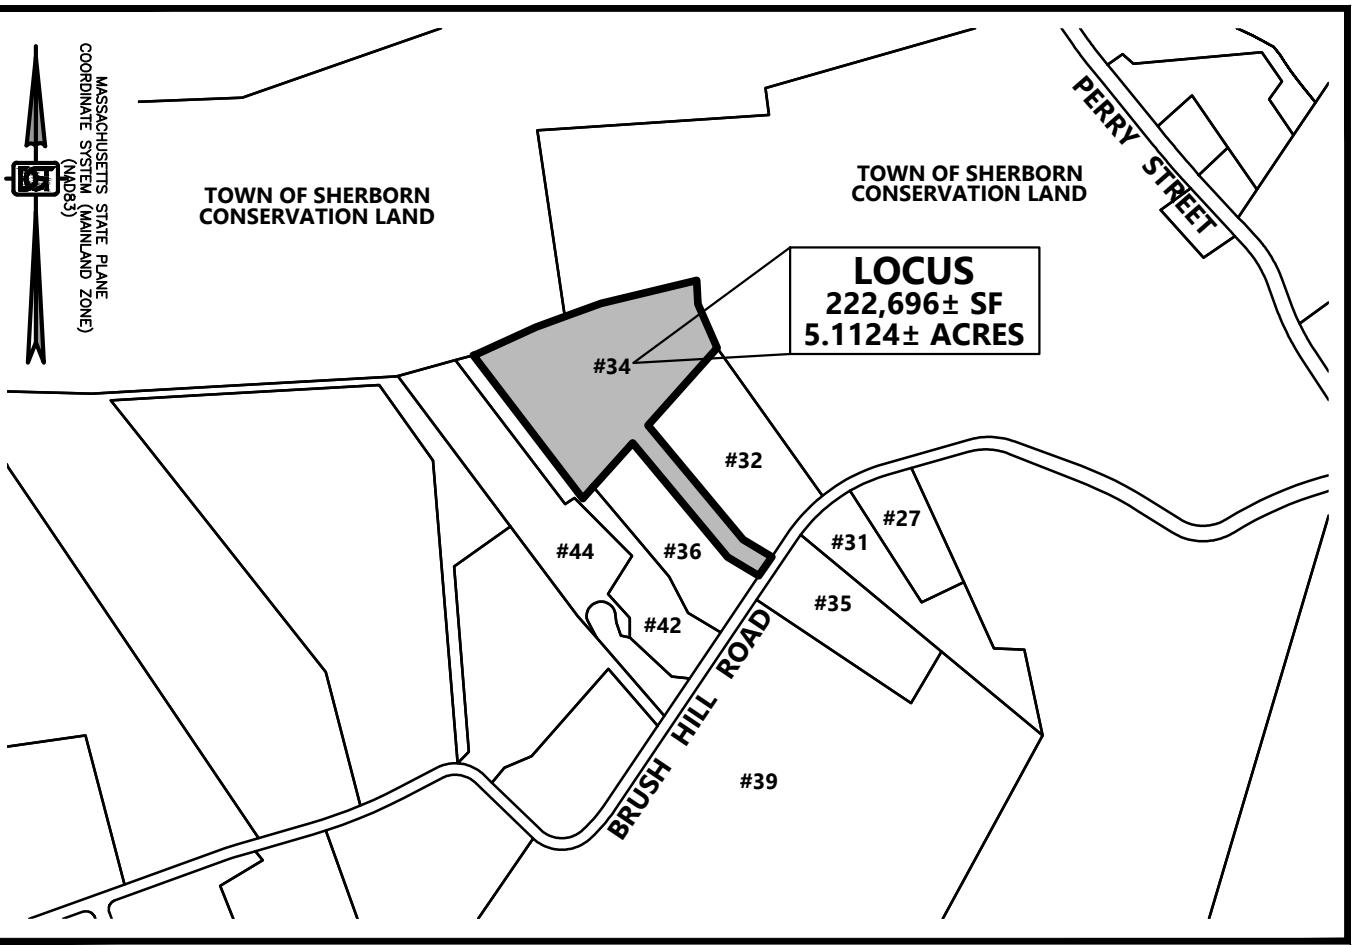

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TOPOGRAPHIC PLAN OF LAND IN SHERBORN MASSACHUSETTS
BY DGT ASSOCIATES, DATED 06-25-2024

Table 1. Summary of Project Site Conditions

General Site Conditions	Land Condition	Land Breakdown	Acres	Square Feet	Coverage (%)	
		Total Area	5.1124	222,696	100.0%	
	Unusable Land	Wetlands	0.0000	0	0.0%	
	Usable Land	Upland	5.1124	222,696	100.0%	
Existing Conditions	Disturbed	Total	0.0924	4,025	1.8%	
		Building	0.0000	0	0.0%	
		Pavement	0.0000	0	0.0%	
		Sidewalk	0.0000	0	0.0%	
	Pervious	Lawn (usable open space)	0.0924	4,025	1.8%	
	Undisturbed	Total	5.0200	218,671	98.2%	
		Usable Open Space	Upland Woods	5.0200	218,671	98.2%
		Unusable Open Space	Wetlands	0.0000	0	0.0%
		Total Usable Open Space	Lawn / Woods	5.1124	222,696	100.0%
Proposed Conditions	Disturbed	Total	4.3945	191,423	86.0%	
		Building	0.3818	16,630	7.5%	
		Pavement	0.7520	32,756	14.7%	
		Sidewalk	0.0000	0	0.0%	
	Pervious	Lawn (usable open space)	3.2607	142,037	63.8%	
	Undisturbed	Total	0.7466	32,520	14.6%	
		Usable Open Space	Upland Woods	0.7466	32,520	14.6%
		Unusable Open Space	Wetlands	0.0000	0	0.0%
		Total Usable Open Space	Lawn / Woods	4.0073	174,557	78.4%

Table 2. Summary of Proposed Buildings

Table 2. Summary of Proposed

Table 3. Zoning Summary Table (Sherborn Residential B District)

Item	Required		Proposed Conditions		Waiver Required		
Minimum Lot Area	2	acres	5.1124	acres	No		
Minimum Frontage	200	feet	50.02	feet	Yes		
Minimum Lot Width	200	feet	50.02	feet	Yes		
Minimum Lot Depth	N/A		N/A		N/A		
Minimum Front Setback	60	feet	513.5	feet	No		
Minimum Side Setback	40	feet	50.8	feet	No		
Minimum Rear Setback	30	feet	51.5	feet	No		
Maximum Height (stories)	2.5	stories	2	stories	No		
Maximum Height (feet)	35	feet	> 35	feet	No		
Maximum Lot Coverage	N/A		N/A		N/A		
Lot Coverage							
Building	7.5%						
Parking / Paved Areas	14.7%						
Usable Open Space	78.4%						
Unusable Open Space (wetlands)	0.0%						
Lot Coverage	22.2%						

APPLICANT:
FENIX PARTNERS BRUSH HILL, LLC
177 LAKE STREET
SHERBORN, MA 01770

OWNER:
FENIX PARTNERS BRUSH HILL, LLC
ref.
MIDDLESEX REGISTRY OF DEEDS
BOOK: 81892 PAGE: 265

PARCEL ID: **MAP 1, LOT 0, BLOCK 18**

COMMONWEALTH OF MASSACHUSETTS
BERT E.
COREY
CIVIL
No. 48423
REGISTERED
PROFESSIONAL ENGINEER

Bert E. Corey
9/19/24

NO	APP	DATE	DESCRIPTION
2	BEC	9/19/24	PER BOH REVIEW COMMENTS
1	BEC	6/26/24	DESIGN DEVELOPMENT

NO.	APP	DATE	DESCRIPTION
DATE: JUNE 4, 2024			
SCALE: AS NOTED			
DESIGN: KMR/BEC	DRAFTED: KMR	CHECKED: BEC	
PROJECT TITLE:			

BRUSH HILL HOMES

**34 BRUSH HILL ROAD
SHERBORN, MA 01770**

TITLE SHEET

**SHEET:
1 OF 17**

**PROJECT NO.:
F-25889**

C-1


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OWNER:
FENIX PARTNERS BRUSH HILL, LLC
ref.
MIDDLESEX REGISTRY OF DEEDS
BOOK: 81892 PAGE: 265

PARCEL ID: **MAP 1, LOT 9, BLOCK 18**

ISSUED FOR:

**COMPREHENSIVE
PERMIT APPLICATION**

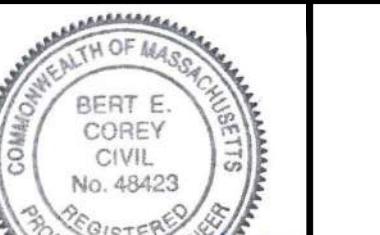

 <i>Bent E 9/19/24</i>			
2	BEC	9/19/24	PER BOH REVIEW COMMENTS
1	BEC	6/26/24	DESIGN DEVELOPMENT
NO.	APP.	DATE	DESCRIPTION

DATE:	JUNE 4, 2024	
SCALE:	1" = 40'	
DESIGN: KMR/BEC	DRAFTED: KMR	CHECKED: BEC
PROJECT TITLE:		

BRUSH HILL HOMES

**34 BRUSH HILL ROAD
SHERBORN, MA 01770**

SHEET TITLE:

OVERALL SITE PLAN

SHEET:
2 OF 17

PROJECT NO.:
F-25889

C-2

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EROSION AND SEDIMENT CONTROL NOTES

1. CONSTRUCTION PERIOD EROSION AND SEDIMENT CONTROL

1.1 THE PURPOSE OF THE CONSTRUCTION PERIOD EROSION AND SEDIMENT CONTROL PLAN IS TO MINIMIZE THE INTRODUCTION OF SEDIMENTS INTO PUBLIC RIGHT OF WAYS, ABUTTING PROPERTIES, AND TO POST-DEVELOPMENT STORMWATER BMP'S RESULTING FROM THE LAND DISTURBANCE ACTIVITIES DURING CONSTRUCTION.

1.2 INSPECTIONS SHALL BE CONDUCTED BY THE GENERAL CONTRACTOR ON A BI-WEEKLY BASIS (EVERY TWO WEEKS), OR FOLLOWING SIGNIFICANT STORM EVENTS (RAINFALL OF 0.5" OR MORE) THAT CAN AFFECT THE SEDIMENT AND EROSION CONTROL PRACTICES IMPLEMENTED AT THE SITE. THE PURPOSE OF THE INSPECTIONS IS TO EVALUATE THE EFFECTIVENESS OF THE CONTROLS AND ANY REQUIRED MAINTENANCE ACTIVITIES. IF AN EROSION/SEDIMENTATION CONTROL MEASURE IS FOUND TO BE INADEQUATE FOR PROPERLY CONTROLLING SEDIMENT, AN ADEQUATE MEASURE SHALL BE DESIGNED AND IMPLEMENTED. A COPY OF THE WRITTEN INSPECTION SHALL BE KEPT ON FILE AT THE CONSTRUCTION SITE.

1.3 DURING CONSTRUCTION, PROPOSED STORMWATER MANAGEMENT STRUCTURES THAT INFILTRATE RUNOFF ARE PARTICULARLY SENSITIVE TO DAMAGE BY SEDIMENT. INFILTRATION TECHNOLOGIES ARE NOT DESIGNED TO HANDLE THE HIGH CONCENTRATIONS OF SEDIMENTS TYPICALLY FOUND IN CONSTRUCTION RUNOFF, AND MUST BE PROTECTED FROM CONSTRUCTION RELATED SEDIMENT. THE CONTRACTOR SHALL USE THE FOLLOWING PROCEDURES TO PROTECT THESE SYSTEMS: PROTECT INFILTRATION SYSTEMS, TRENCH DRAIN, AND CATCH BASINS UNTIL THE TRIBUTARY DRAINAGE AREA IS STABLE OR THE RUNOFF IS TREATED TO BE ESSENTIALLY FREE FROM SEDIMENT TO THE SATISFACTION OF THE ENGINEER. THE CONTRACTOR SHALL PROVIDE TEMPORARY BY-PASS SYSTEMS AS NECESSARY TO PREVENT CONSTRUCTION SITE RUNOFF FROM ENTERING THE INFILTRATION SYSTEMS. THE INFILTRATION SYSTEMS SHALL REMAIN OFF-LINE AND PROTECTED. CLEAN ROOF RUNOFF MAY DISCHARGE INTO THE INFILTRATION SYSTEMS IF IT IS PIPED DIRECTLY TO THE SYSTEMS AND NOT DIRECTED OVER DISTURBED AREAS.

1.4 NO STOCKPILING IS ALLOWED WITHIN THE FOOTPRINT OF THE PROPOSED INFILTRATION SYSTEMS OR THE FOOTPRINT OF THE PROPOSED SOIL ABSORPTION FIELD. CONTRACTOR IS TO LOCATE THE PROPOSED AREAS FOR THESE SYSTEMS PRIOR TO THE START OF CONSTRUCTION.

1.5 DURING THE INSTALLATION OF THE INFILTRATION SYSTEMS, NO PARKING WILL BE PERMITTED OVER THE SYSTEM UNTIL IT HAS BEEN PROPERLY BACKFILLED AND PROTECTED FROM SEDIMENT AND VEHICULAR LOADS.

1.6 NO PARKING IS ALLOWED OVER THE FOOTPRINT OF THE PROPOSED SOIL ABSORPTION SYSTEM AT ANYTIME DURING THE CONSTRUCTION PROCESS.

2. GENERAL PERFORMANCE STANDARDS:

2.1 THE CONTRACTOR SHALL INSTALL, ROUTINELY INSPECT AND MAINTAIN ALL SEDIMENT AND EROSION CONTROLS SUCH THAT THEY ARE IN PROPER WORKING ORDER AT ALL TIMES DURING THE CONSTRUCTION PROJECT UNTIL SUCH TIME AS ALL AREAS OF THE SITE TRIBUTARY TO THOSE EROSION CONTROLS ARE IN A PERMANENTLY STABILIZED CONDITION.

2.2 THE CONTRACTOR SHALL MANAGE THE SITE SUCH THAT EROSION AND SEDIMENT FROM RUNOFF AND WIND BLOWN DUST ARE CONTROLLED AND MINIMIZED AT ALL TIMES. THE EROSION CONTROLS SHOWN ON THIS PLAN INCLUDE THE INITIAL SET OF EROSION CONTROLS AND BASIC FORMATION OF THE SITE TO MEET THE REQUIREMENTS OF BEST MANAGEMENT PRACTICES. THE CONTRACTOR SHALL MANAGE THE SITE PERIODICALLY WHICH MAY NOT BE STABILIZED AREAS OF EXPOSED SOILS; INSTALL TEMPORARY COVER; MAKE NECESSARY ADJUSTMENTS TO THE EROSION CONTROL INSTALLATIONS TO IMPROVE FUNCTION; PROVIDE TEMPORARY SEDIMENT BASINS; INSTALL ADDITIONAL EROSION CONTROL WHERE NECESSARY.

2.3 THE EROSION CONTROL WORK SHOWN ON THIS PLAN ARE ALSO SUBJECT TO OTHER STATE AND LOCAL APPROVALS. THE CONTRACTOR SHALL OBTAIN AND BE RESPONSIBLE FOR COMPLIANCE WITH THE CONDITIONS AND REQUIREMENTS OF THOSE PERMITS.

2.4 DESIGN, INSTALLATION AND MAINTENANCE OF SEDIMENT AND EROSION CONTROLS SHALL BE IN ACCORDANCE WITH BEST MANAGEMENT PRACTICES AS FLOWING: THE GUIDELINES INCLUDE THE FOLLOWING:
 - "CONSTRUCTION EROSION AND SEDIMENT CONTROL PRACTICES" U.S. ENVIRONMENTAL PROTECTION AGENCY, OCTOBER 1992;
 - "MASSACHUSETTS EROSION AND SEDIMENT CONTROL GUIDELINES FOR URBAN AND SUBURBAN AREAS, A GUIDE FOR PLANNERS, DESIGNERS AND MUNICIPAL OFFICIALS", MASS. EXECUTIVE OFFICE OF ENVIRONMENTAL AFFAIRS, MAY 2003.
 - U.S.D.A. NATURAL RESOURCES AND CONSERVATION SERVICES (NRCS) GUIDELINES.

3. FEDERAL NPDES PHASE II COMPLIANCE:

3.1 THIS PROJECT IS SUBJECT TO THE FEDERAL CLEAN WATER ACT REQUIREMENTS FOR CONSTRUCTION SITES ADMINISTERED BY THE U.S. ENVIRONMENTAL PROTECTION AGENCY (EPA). THIS PROGRAM IS THE "NATIONAL POLLUTANT DISCHARGE ELIMINATION SYSTEM (NPDES) - PHASE II FOR CONSTRUCTION SITES FOR COMPLIANCE WITH THIS PROGRAM, THE CONTRACTOR SHALL BE RESPONSIBLE FOR PREPARING A COMPLETE "STORMWATER POLLUTION PREVENTION PLAN" (SWPPP) IN CONFORMANCE WITH THE CURRENT CONSTRUCTION GENERAL PERMIT AND FILING A NOTICE OF INTENT WITH THE EPA UNDER THE NPDES PROGRAM. THE CONTRACTOR SHALL THEN MANAGE THE SITE IN COMPLIANCE WITH THE SWPPP AND IN COMPLIANCE WITH THE CONSTRUCTION GENERAL PERMIT. NOTE THAT THE SWPPP IS TO BE CONSISTENT WITH THIS EROSION AND SEDIMENT CONTROL PLAN. THE CONTRACTOR SHALL PREPARE A CONSTRUCTION GENERAL PERMIT. THE CONSTRUCTION GENERAL PERMIT SHALL NOT BE REQUIRED TO MEET THE REQUIREMENTS OF A SWPPP, BUT IS NOT TO BE CONSIDERED AS MEETING THE FULL REQUIREMENTS OF A SWPPP PREPARED FOR COMPLIANCE WITH THE NPDES PROGRAM.

4. PERIMETER FIBER LOG / SILT FENCING AND LIMIT OF WORK:

4.1 PRIOR TO ANY DISTURBANCE OR ALTERATIONS OF ANY AREA ON THE SITE, AN EROSION CONTROL BARRIER AND CONSTRUCTION FENCE SHALL BE INSTALLED IN THE LOCATIONS SHOWN ON THE PLAN.

4.2 INSTALL THE FIBER LOGS ON THE UPHILL SIDE OF THE SILT FENCE AS SHOWN IN THOSE AREAS WHERE THE TOPOGRAPHY INDICATES THAT STORMWATER RUNOFF WILL BE CONCENTRATED (AT LOW POINTS). ADDITIONAL FIBER LOGS, AS NECESSARY, SHALL BE STAKED ON THE UPGRADE SIDE OF THE SEDIMENT BARRIER FOR ADDED FILTRATION AND PROTECTION. THE REQUIRED LOCATIONS FOR THE ADDITIONAL FIBER LOG INSTALLATION WILL BE SELECTED BY THE ENGINEER AND / OR THE AUTHORIZED INSPECTOR / SWPPP COORDINATOR UPON COMPLETION OF THE SEDIMENT BARRIER INSTALLATION. (SEE DETAIL).

4.3 ONCE INSTALLED, THE STAKED FIBER LOGS AND CONSTRUCTION FENCE SHALL BE MAINTAINED IN PLACE UNTIL ALL AREAS UPGRADED FROM THE BARRIERS HAVE BEEN PERMANENTLY STABILIZED.

4.4 ALL DISTURBED AREAS NOT OTHERWISE DEVELOPED OR WHERE SPECIAL STABILIZATION MEASURES OR LANDSCAPE PLANTINGS ARE PROPOSED SHALL BE LOAMED AND SEEDED. SIX INCHES OF LOAM TOPSOIL (MIN. COMPACTED DEPTH) SHALL BE APPLIED UNLESS, OTHERWISE SPECIFIED. (SEE LANDSCAPE PLAN AND OTHER PLANS AS APPLICABLE).

4.5 THE PERIMETER FIBER LOGS AND CONSTRUCTION FENCE ARE ALSO LIMITS OF WORK. ALL AREAS OUTSIDE THE LIMIT ARE TO BE LEFT UNDISTURBED. DURING THE SITE WORK, ALL PERSONS AND EQUIPMENT SHALL STAY OUT OF THESE AREAS TO PRESERVE THE EXISTING VEGETATION AND SOIL COVER.

5. CONSTRUCTION ENTRANCE:

5.1 AT THE START OF SITE WORK, A STONE CONSTRUCTION ENTRANCE SHALL BE INSTALLED AT THE ACCESS TO THE SITE FROM THE ACCESS EASEMENT DRIVEWAY TO CONTROL THE TRACKING OF MUD OFF THE SITE. THE ENTRANCE SHALL BE MAINTAINED UNTIL THE SITE IS IN A STABILIZED CONDITION WHEN THE POSSIBILITY OF VEHICLES TRACKING MUD OFF SITE HAS BEEN ELIMINATED.

5.2 THE CONTRACTOR SHALL SWEEP THE ADJACENT ROADWAYS WHEN MUD, DUST, DIRT, DEBRIS, ETC. HAS SHOWN SIGNS OF BUILDUP ON THE ROADWAYS EXITING THE SITE. THE CONTRACTOR SHALL PAY PARTICULAR ATTENTION TO THIS MATTER AND IMMEDIATE ATTENTION IS ALWAYS REQUIRED.

6. DEWATERING OF EXCAVATIONS:

6.1 DISCHARGE FROM DEWATERING PUMPS OR TEMPORARY TRENCH OR EXCAVATION DRAINS SHALL NOT BE DISCHARGED DIRECTLY TO THE ON-SITE DRAINAGE SYSTEM, WETLANDS, OR SEWAGE DISPOSAL SYSTEM. DISCHARGES SHALL BE DIRECTED TO A TREATMENT SYSTEM CONSISTING OF A SEDIMENT BASIN, STRAW BALE SEDIMENT BASIN, FILTER BAG SYSTEM OR OTHER APPROVED METHOD TO FILTER THE DISCHARGE WATER AND PREVENT EROSION.

6.2 ALL DEWATERING DRAINS ASSOCIATED WITH CONSTRUCTION ACTIVITIES SHALL COMPLY WITH THE TOWN OF SHERBORN REQUIREMENTS, UNITED STATES ENVIRONMENTAL PROTECTION AGENCY, MASSACHUSETTS DEP AND OTHER APPROPRIATE AGENCIES. UNDER NO CIRCUMSTANCE SHALL DEWATERING DRAINAGE BE DISCHARGED INTO SANITARY SEWER.

7. SOIL STOCKPILES:

7.1 STOCKPILES OF SOIL MATERIALS SHALL BE PLACED WITHIN AREAS THAT ARE PROTECTED BY PERIMETER EROSION CONTROLS, OR SHALL BE SURROUNDED BY PROPER SILT FENCE OR FIBER LOGS.

7.2 STOCKPILES THAT ARE TO BE IN PLACE FOR EXTENDED PERIODS OF TIME (MORE THAN 30 DAYS) SHALL BE COVERED OR OTHERWISE TEMPORARILY STABILIZED IN ACCORDANCE WITH BEST MANAGEMENT PRACTICES.

8. CATCH BASIN INLET PROTECTION:

8.1 CATCH BASINS AND TRENCH DRAINS WITHIN THE WORK AREA OR THAT WILL RECEIVE RUNOFF FROM THE WORK AREA SHALL BE PROTECTED WITH A SILT SACK AND OR OTHER APPROVED INSTALLATION TO MINIMIZE THE SEDIMENT LOAD TO THE CATCH BASIN.

9. DUST CONTROL:


9.1 THE CONTRACTOR SHALL TAKE APPROPRIATE MEASURES DURING SITE WORK TO MINIMIZE WIND BLOWN DUST FROM EXPOSED SOIL SURFACES. MEASURES INCLUDE BUT ARE NOT LIMITED TO:
 - SPRINKLING WATER ON EXPOSED SURFACES
 - APPLICATION OF TEMPORARY COVER SUCH AS HYDRO MULCH AND TACKIFIER, STRAW MATTING, JUTE NETTING ETC.

APPLICANT:
FENIX PARTNERS BRUSH HILL, LLC
 177 LAKE STREET
 SHERBORN, MA 01770

OWNER:
FENIX PARTNERS BRUSH HILL, LLC
 ref.
MIDDLESEX REGISTRY OF DEEDS
 BOOK: 81892 PAGE: 265

PARCEL ID:
MAP 1, LOT 0, BLOCK 18

ISSUED FOR:
COMPREHENSIVE PERMIT APPLICATION

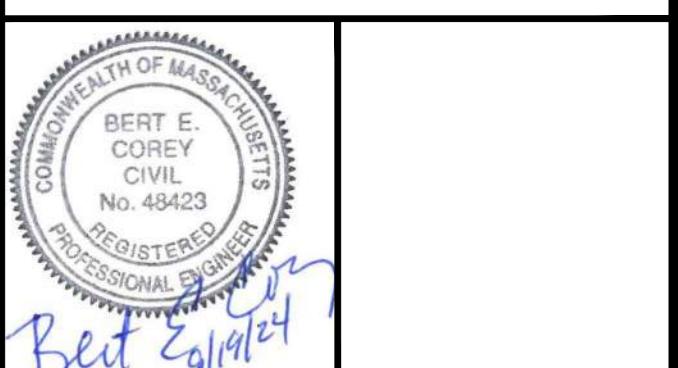

Beth E. 5/1/24

2	BEC	9/19/24	PER BOH REVIEW COMMENTS
1	BEC	6/26/24	DESIGN DEVELOPMENT

NO. APP. DATE DESCRIPTION

DATE: **JUNE 4, 2024**

SCALE: **1" = 30'**

DESIGN: **KMR/BEC** DRAFTED: **KMR** CHECKED: **BEC**

PROJECT TITLE: **BRUSH HILL HOMES**



34 BRUSH HILL ROAD
 SHERBORN, MA 01770

SHEET TITLE:

EROSION & SEDIMENT CONTROL PLAN & DETAILS - 02

SHEET: 4 OF 17	C-4
PROJECT NO.: F-25889	

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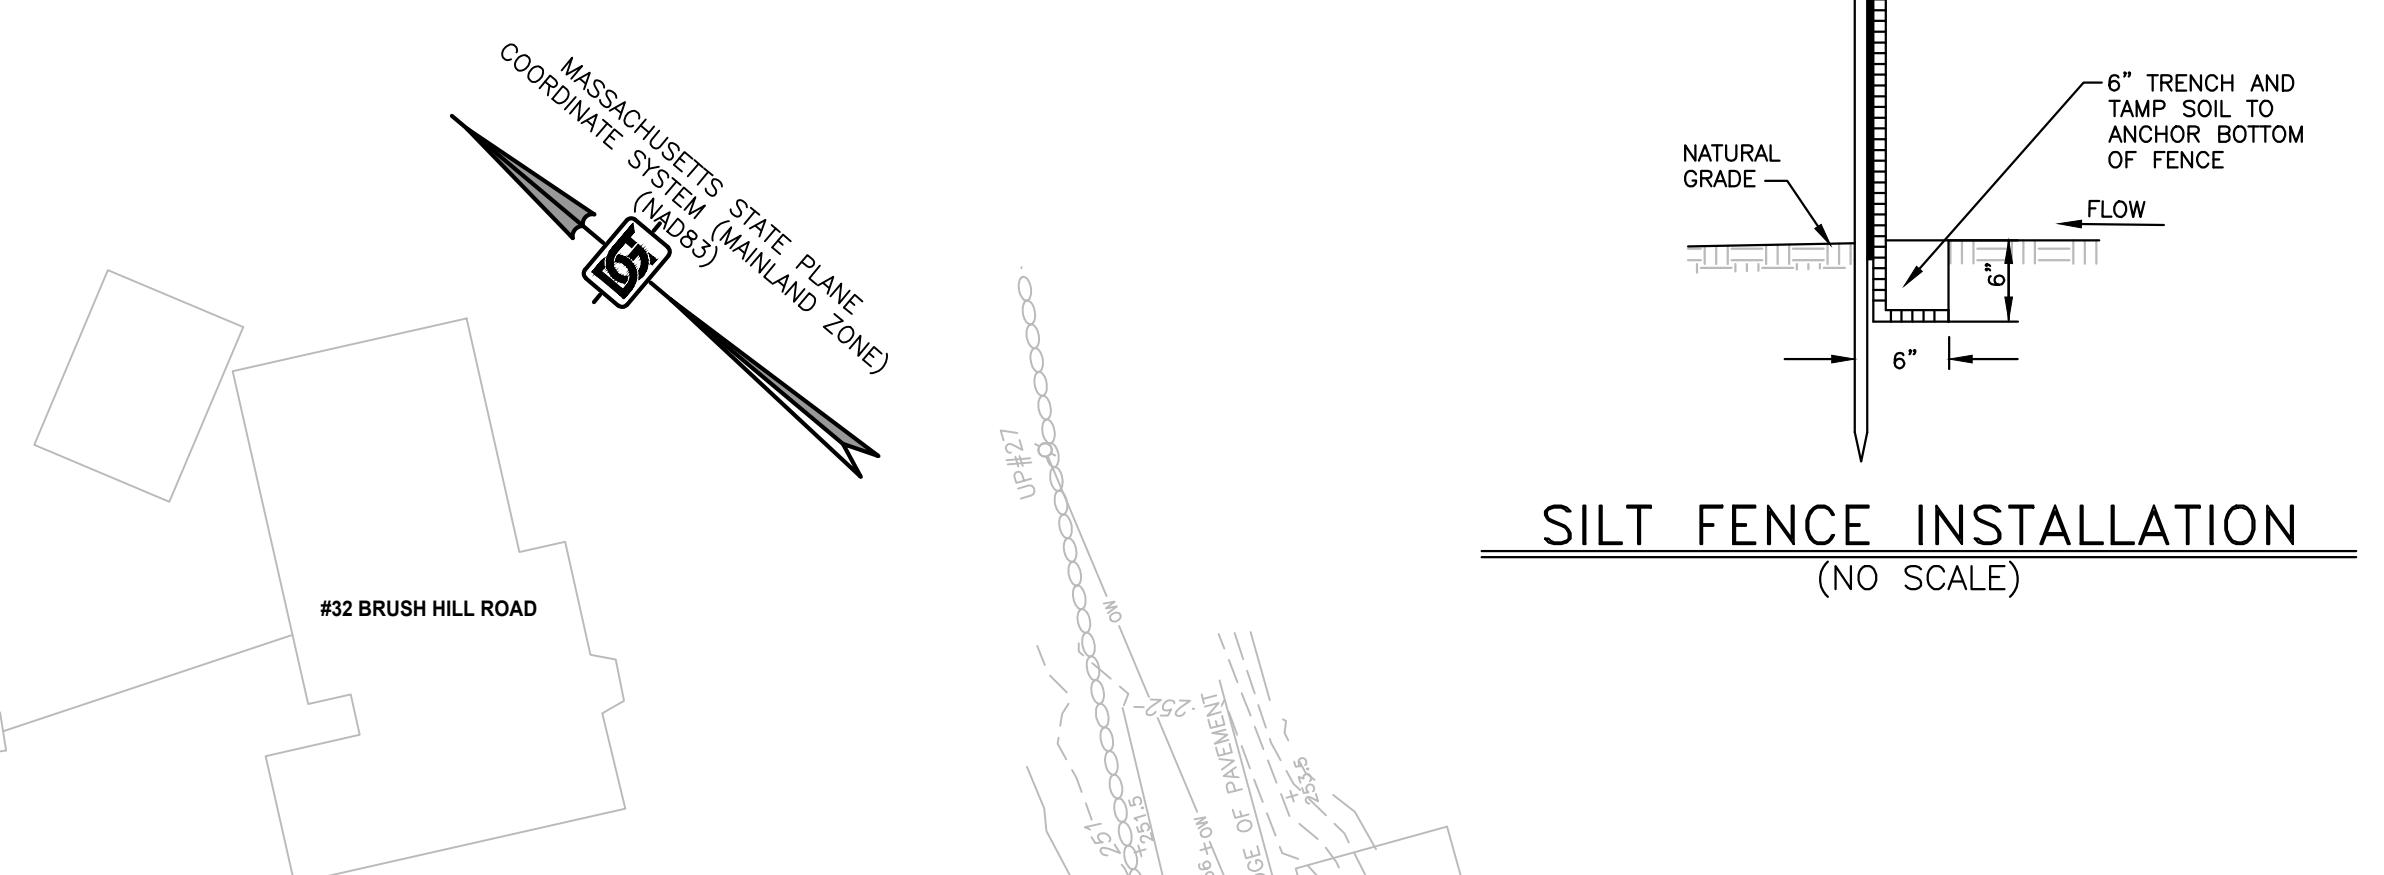


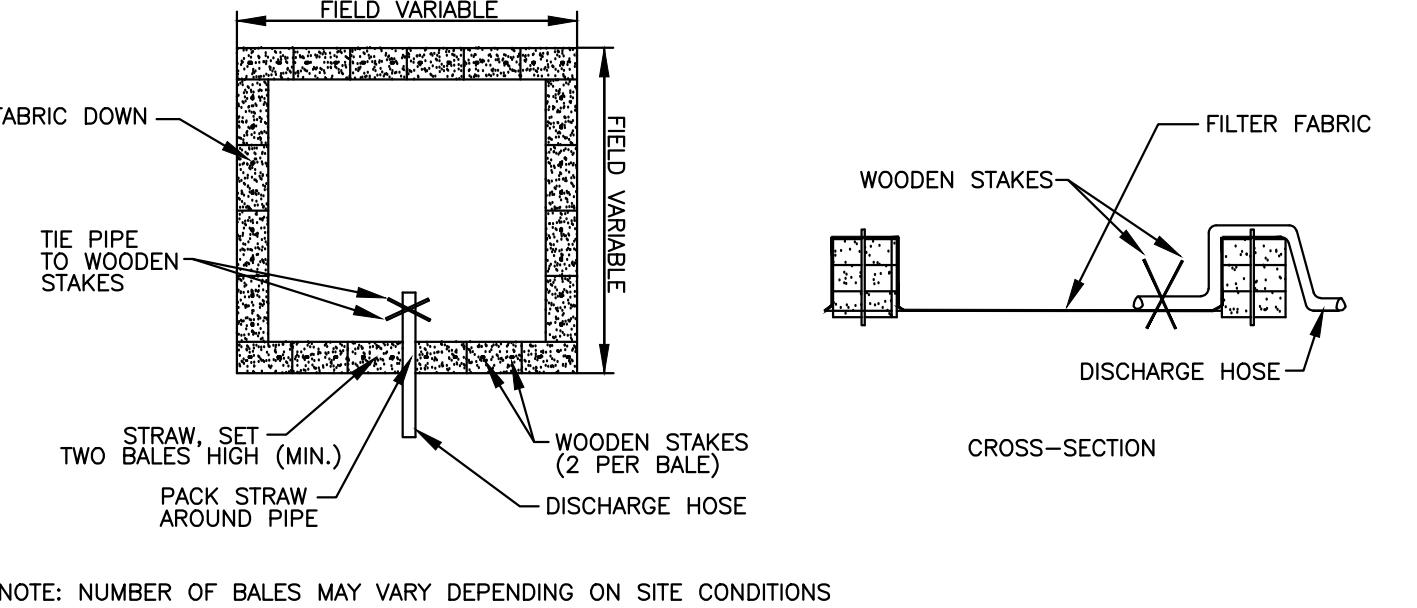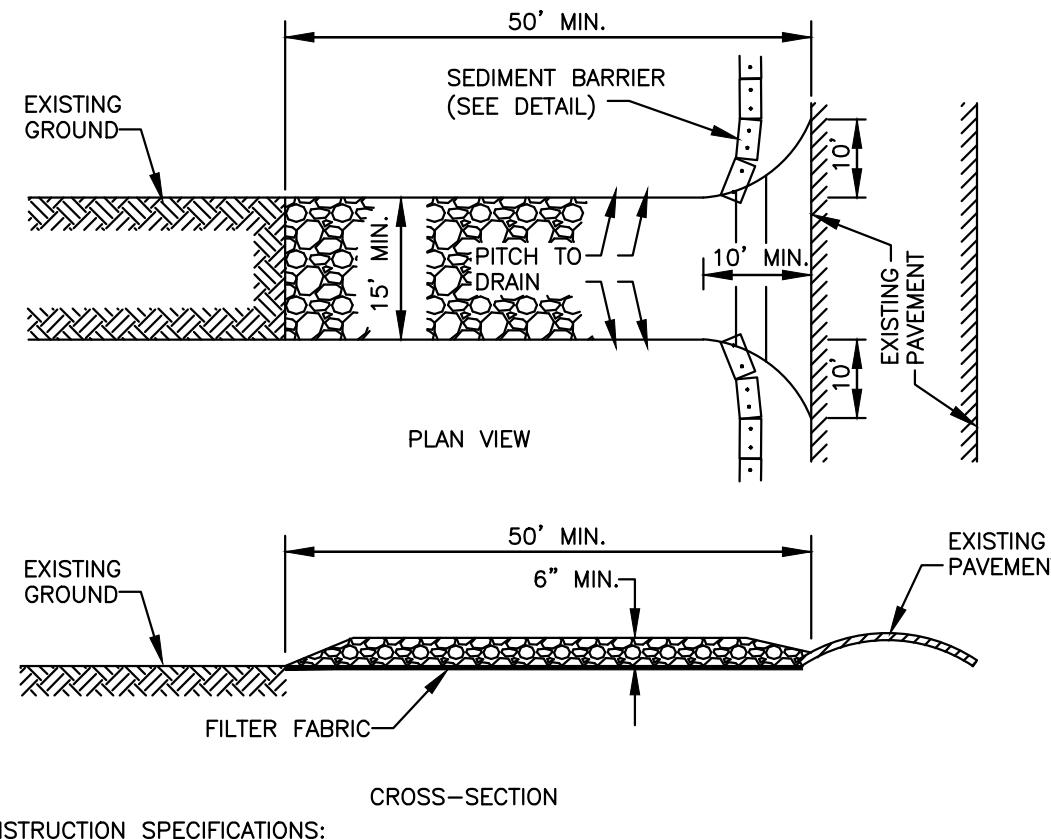STONE TRACKING PAD (CONSTRUCTION ENTRANCE)

(NO SCALE)


CONSTRUCTION FENCE WITH FIBER LOG DETAIL

(NO SCALE)



SILT FENCE INSTALLATION

(NO SCALE)

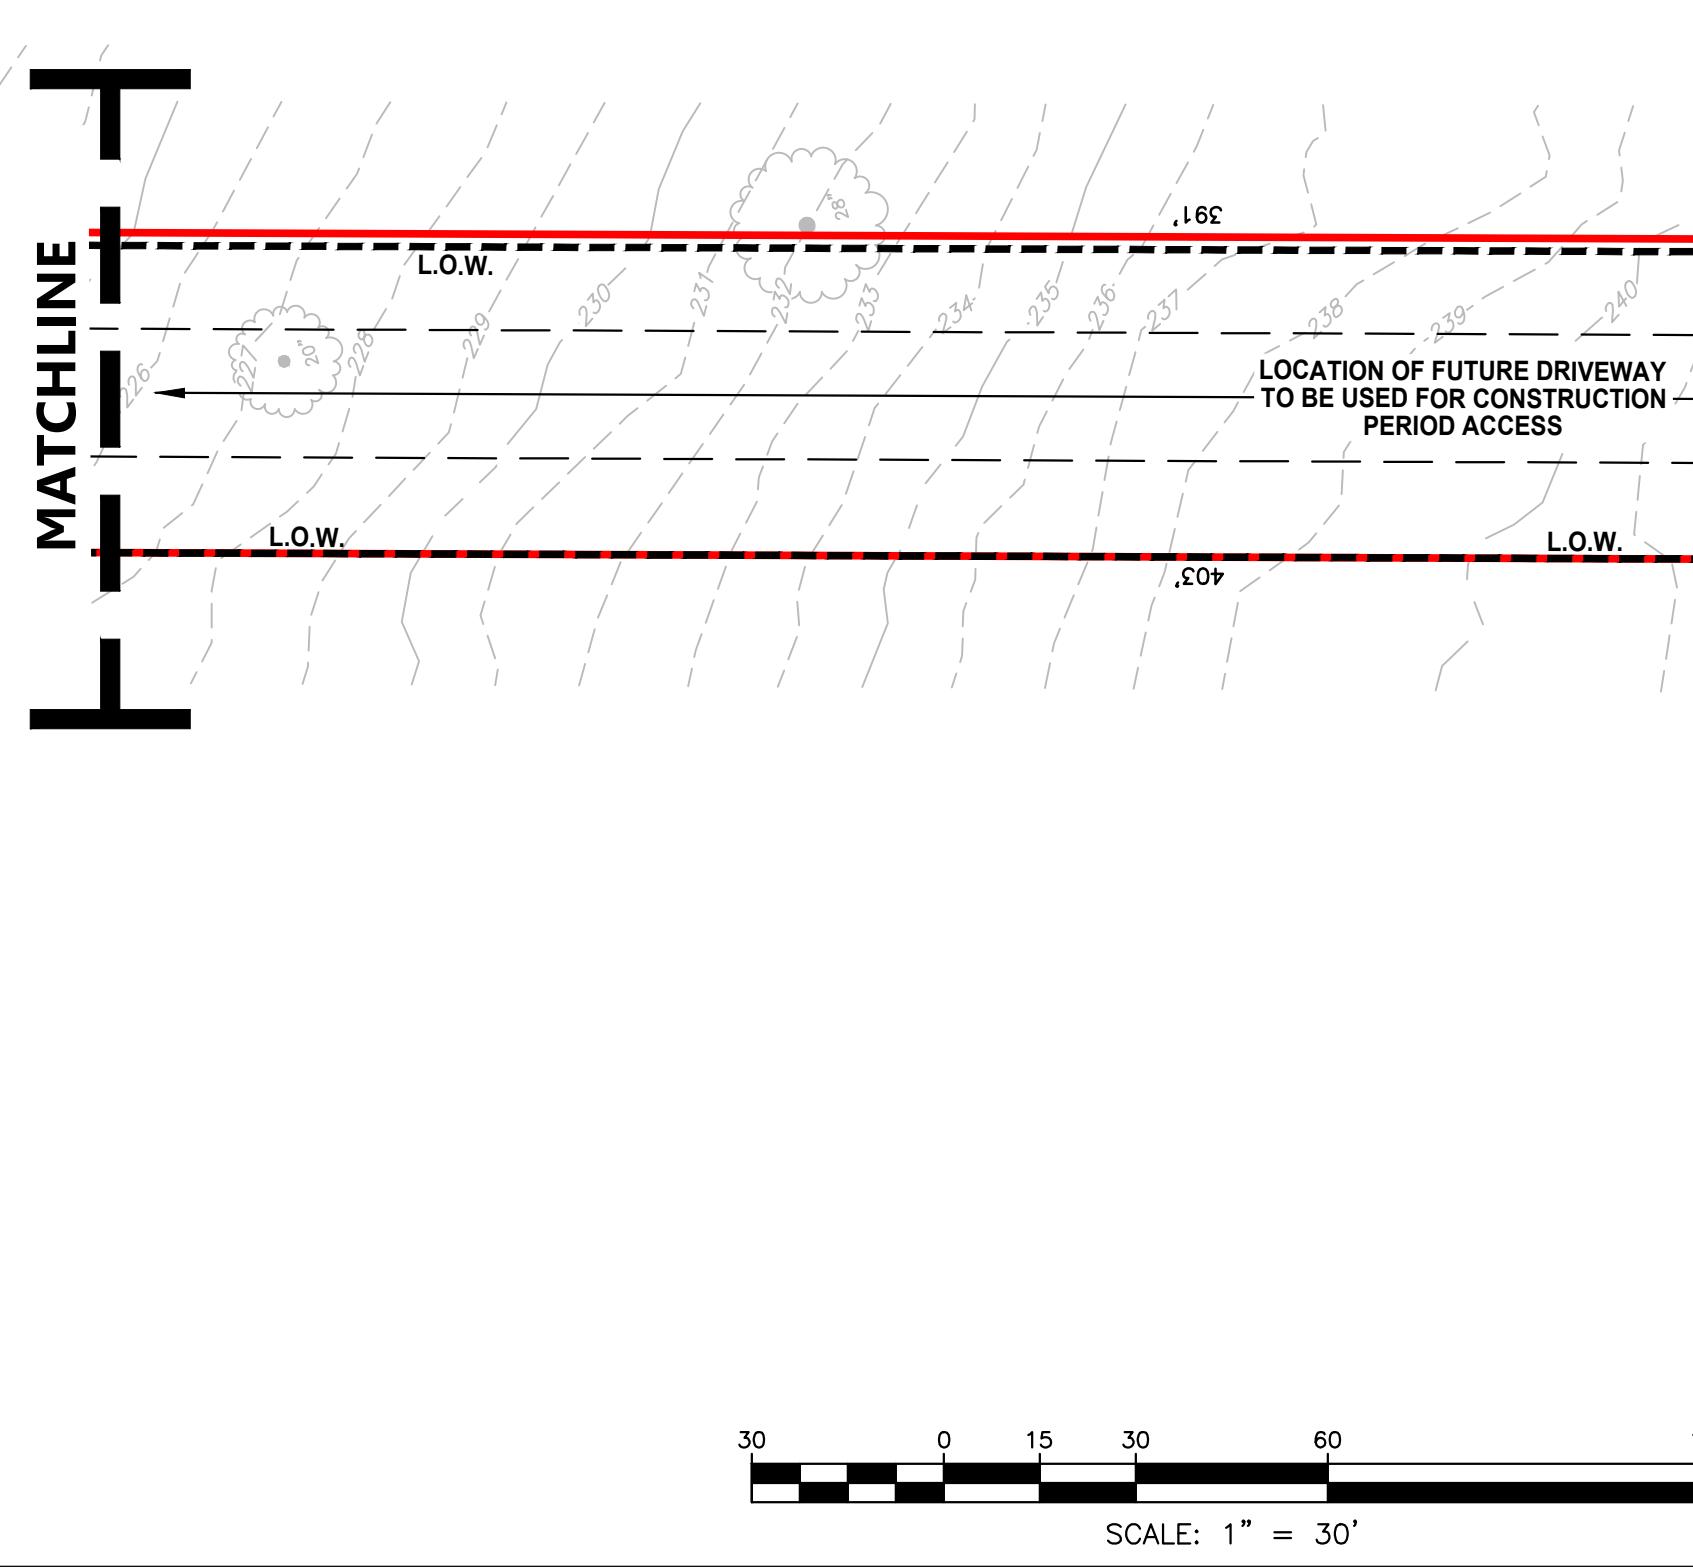

APPLICANT:
FENIX PARTNERS BRUSH HILL, LLC
177 LAKE STREET
SHERBORN, MA 01770

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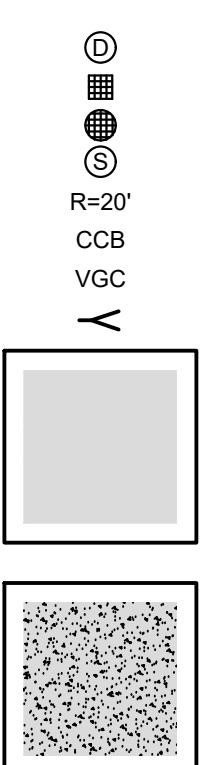
LAYOUT AND MATERIALS PLAN - 01

SHEET: 5 OF 17	C-5
PROJECT NO.: F-25889	

PARKING DATA

EACH DWELLING HAS A TWO CAR GARAGE
EACH DWELLING HAS A DRIVEWAY CAPABLE OF PROVIDING 2 SPACES
EACH DWELLING HAS A TOTAL CAPACITY OF 4 PARKING SPACES

A TOTAL OF 5 VISITOR PARKING SPACES IS PROVIDED
NO PARKING IS PERMITTED ALONG ANY OF THE 20' WIDE SITE ROADWAYS




LEGEND

PROPOSED DRAINAGE STRUCTURE
PROPOSED DEEP SUMP CATCH BASIN
PROPOSED AREA DRAIN
PROPOSED SEWER MANHOLE
RADIUS = 20 FEET
PROPOSED CAPE COD BERM
PROPOSED VERTICAL GRANITE CURB
HDPE FLARED END SECTION

BITUMINOUS CONCRETE PAVEMENT

CONCRETE PAVEMENT

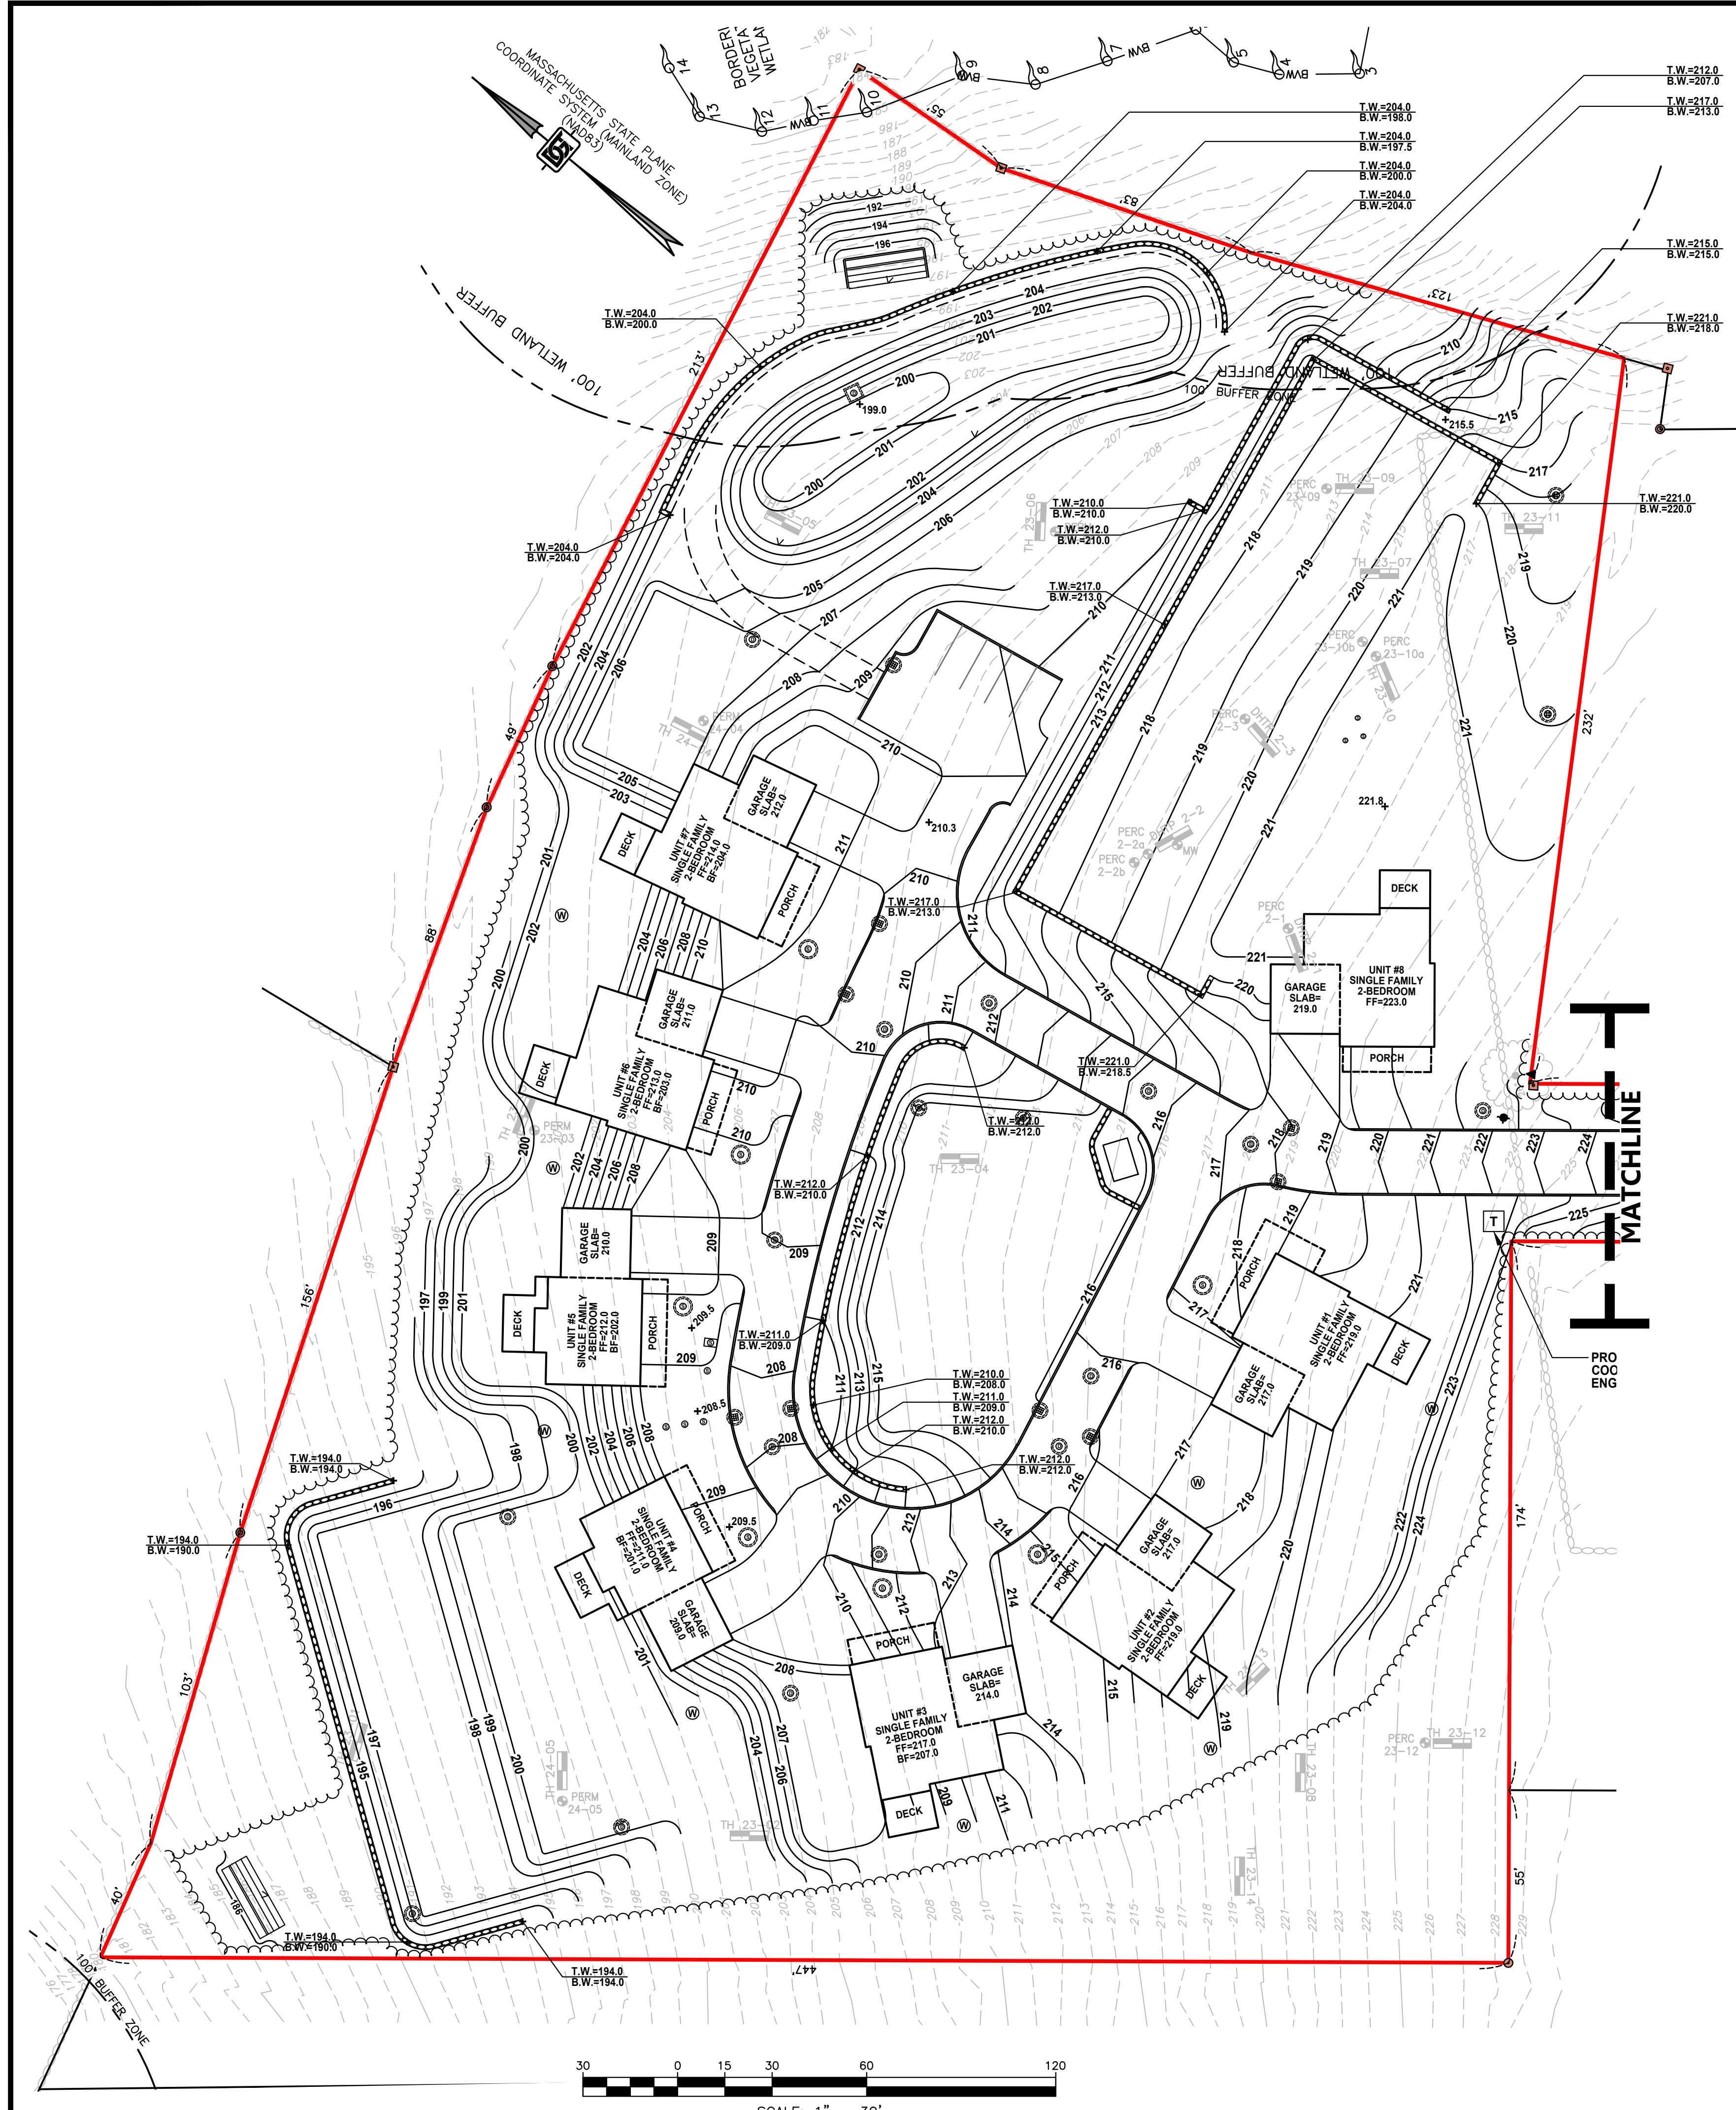

The logo for DGT Associates Surveying & Engineering. It features a large, stylized 'DGT' monogram on the left, with the 'D' and 'G' partially overlapping. To the right of the monogram, the word 'DGT Associates' is written in a bold, sans-serif font. Below this, the words 'Surveying & Engineering' are written in a slightly smaller, also bold, sans-serif font.

Framingham
Boston • Worcester • Preston, CT

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Framingham, MA 01701
508-879-0030


www.DGTassociates.com

APPICANT:
ENIX PARTNERS BRUSH HILL, LLC
177 LAKE STREET
SHERBORN, MA 01770

WNER:
ENIX PARTNERS BRUSH HILL, LLC
ref.
MIDDLESEX REGISTRY OF DEEDS
BOOK: 81892 PAGE: 265

ARCEL ID:

ISSUED FOR: **COMPREHENSIVE
PERMIT APPLICATION**

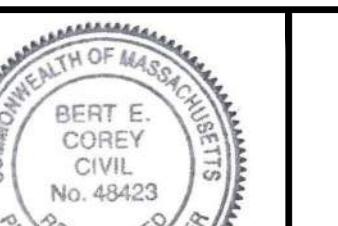

REGISTERED PROFESSIONAL ENGINEER			
Brett E. Clegg 9/19/24			
2	BEC	9/19/24	PER BOH REVIEW COMMENTS
1	BEC	6/26/24	DESIGN DEVELOPMENT
0	APP	DATE	DESCRIPTION

DATE:	JUNE 4, 2024	
SCALE:	1" = 30'	
DESIGN: KMR/BEC	DRAFTED: KMR	CHECKED: BEC
PROJECT TITLE		

BRUSH HILL HOMES

34 BRUSH HILL ROAD SHERBORN, MA 01770

LEGEND

PROPOSED CONTOUR ELEVATION
PROPOSED DRAIN LINE
PROPOSED ROOF DRAIN
PROPOSED DRAINAGE STRUCTURE
PROPOSED DEEP SUMP CATCH BASIN
PROPOSED AREA DRAIN
PROPOSED SEWER MANHOLE
PROPOSED SPOT ELEVATION
PROPOSED TOP OF CURB ELEVATION
PROPOSED BOTTOM OF CURB ELEVATION
PROPOSED TOP OF WALL ELEVATION
PROPOSED BOTTOM OF WALL ELEVATION

HEET TITLE:

SITE GRADING PLAN - 01

SHEET: 7 OF 17	C-7
PROJECT NO.: F-25889	

APPlicant:
ENIX PARTNERS BRUSH HILL, LLC
177 LAKE STREET
SHERBORN, MA 01770

WNER:
ENIX PARTNERS BRUSH HILL, LLC
ref.
MIDDLESEX REGISTRY OF DEEDS
BOOK: 81892 PAGE: 265

ARCEL ID:

MAP 1, LOT 0, BLOCK 18

ISSUED FOR:

COMPREHENSIVE PERMIT APPLICATION



A circular seal with the words "REGISTERED PROFESSIONAL ENGINEER" around the perimeter. A handwritten signature "Bert E. G." is written across the center in blue ink.

2	BEC	9/19/24	PER BOH REVIEW COMMENTS
1	BEC	6/26/24	DESIGN DEVELOPMENT

DATE: JUNE 4, 2024

SCALE: **1" = 30'**

DESIGN: DRAFTED: CHECKED:

PROJECT TITLE:

BRUSH HILL HOMES

34 BRUSH HILL ROAD SHERBORN, MA 01770

HEET TITLE:

DRAINAGE PLAN - 02

SHEET: 10 OF 17	C-10
PROJECT NO.: F-25889	

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MATCHLINE

BRUSH HILL ROAD

MASSACHUSETTS STATE PLANE COORDINATE SYSTEM (MAINLAND ZONE) (NAD83)

#32 BRUSH HILL ROAD

#36 BRUSH HILL ROAD

CB #3
RIM=221.2
INV IN=212.7
INV OUT=212.6

CB #1
RIM=242.0
INV OUT=238.5

CB #2
RIM=242.0
INV OUT=238.5

CB #4
RIM=230.0
INV OUT=226.5

DMH #2
RIM=229.5
INV'S IN=226.1
INV OUT=226.0

DMH #1
RIM=241.5
INV'S IN=238.1
INV OUT=238.0

UP #27

UP #28

WELL

GRANITE


EDGE OF PAVEMENT

UP#NZ 24

LEGEND

LEGEND	
123	PROPOSED CONTOUR ELEVATION
D	PROPOSED DRAIN LINE
RD	PROPOSED ROOF DRAIN
DMH (D)	PROPOSED DRAIN MANHOLE
STU (D)	PROPOSED STORMWATER TREATMENT UNIT
CB	PROPOSED DEEP SUMP CATCH BASIN
AD	PROPOSED AREA DRAIN
OCS (D)	PROPOSED OUTLET CONTROL STRUCTURE
SMH (S)	PROPOSED SEWER MANHOLE
HDPE	HIGH DENSITY POLYETHYLENE
+123.4	PROPOSED SPOT ELEVATION
T.C.=123.4	PROPOSED TOP OF CURB ELEVATION
B.C.=123.4	PROPOSED BOTTOM OF CURB ELEVATION
T.W.=123.4	PROPOSED TOP OF WALL ELEVATION
B.W.=123.4	PROPOSED BOTTOM OF WALL ELEVATION

SCALE: 1" = 30'

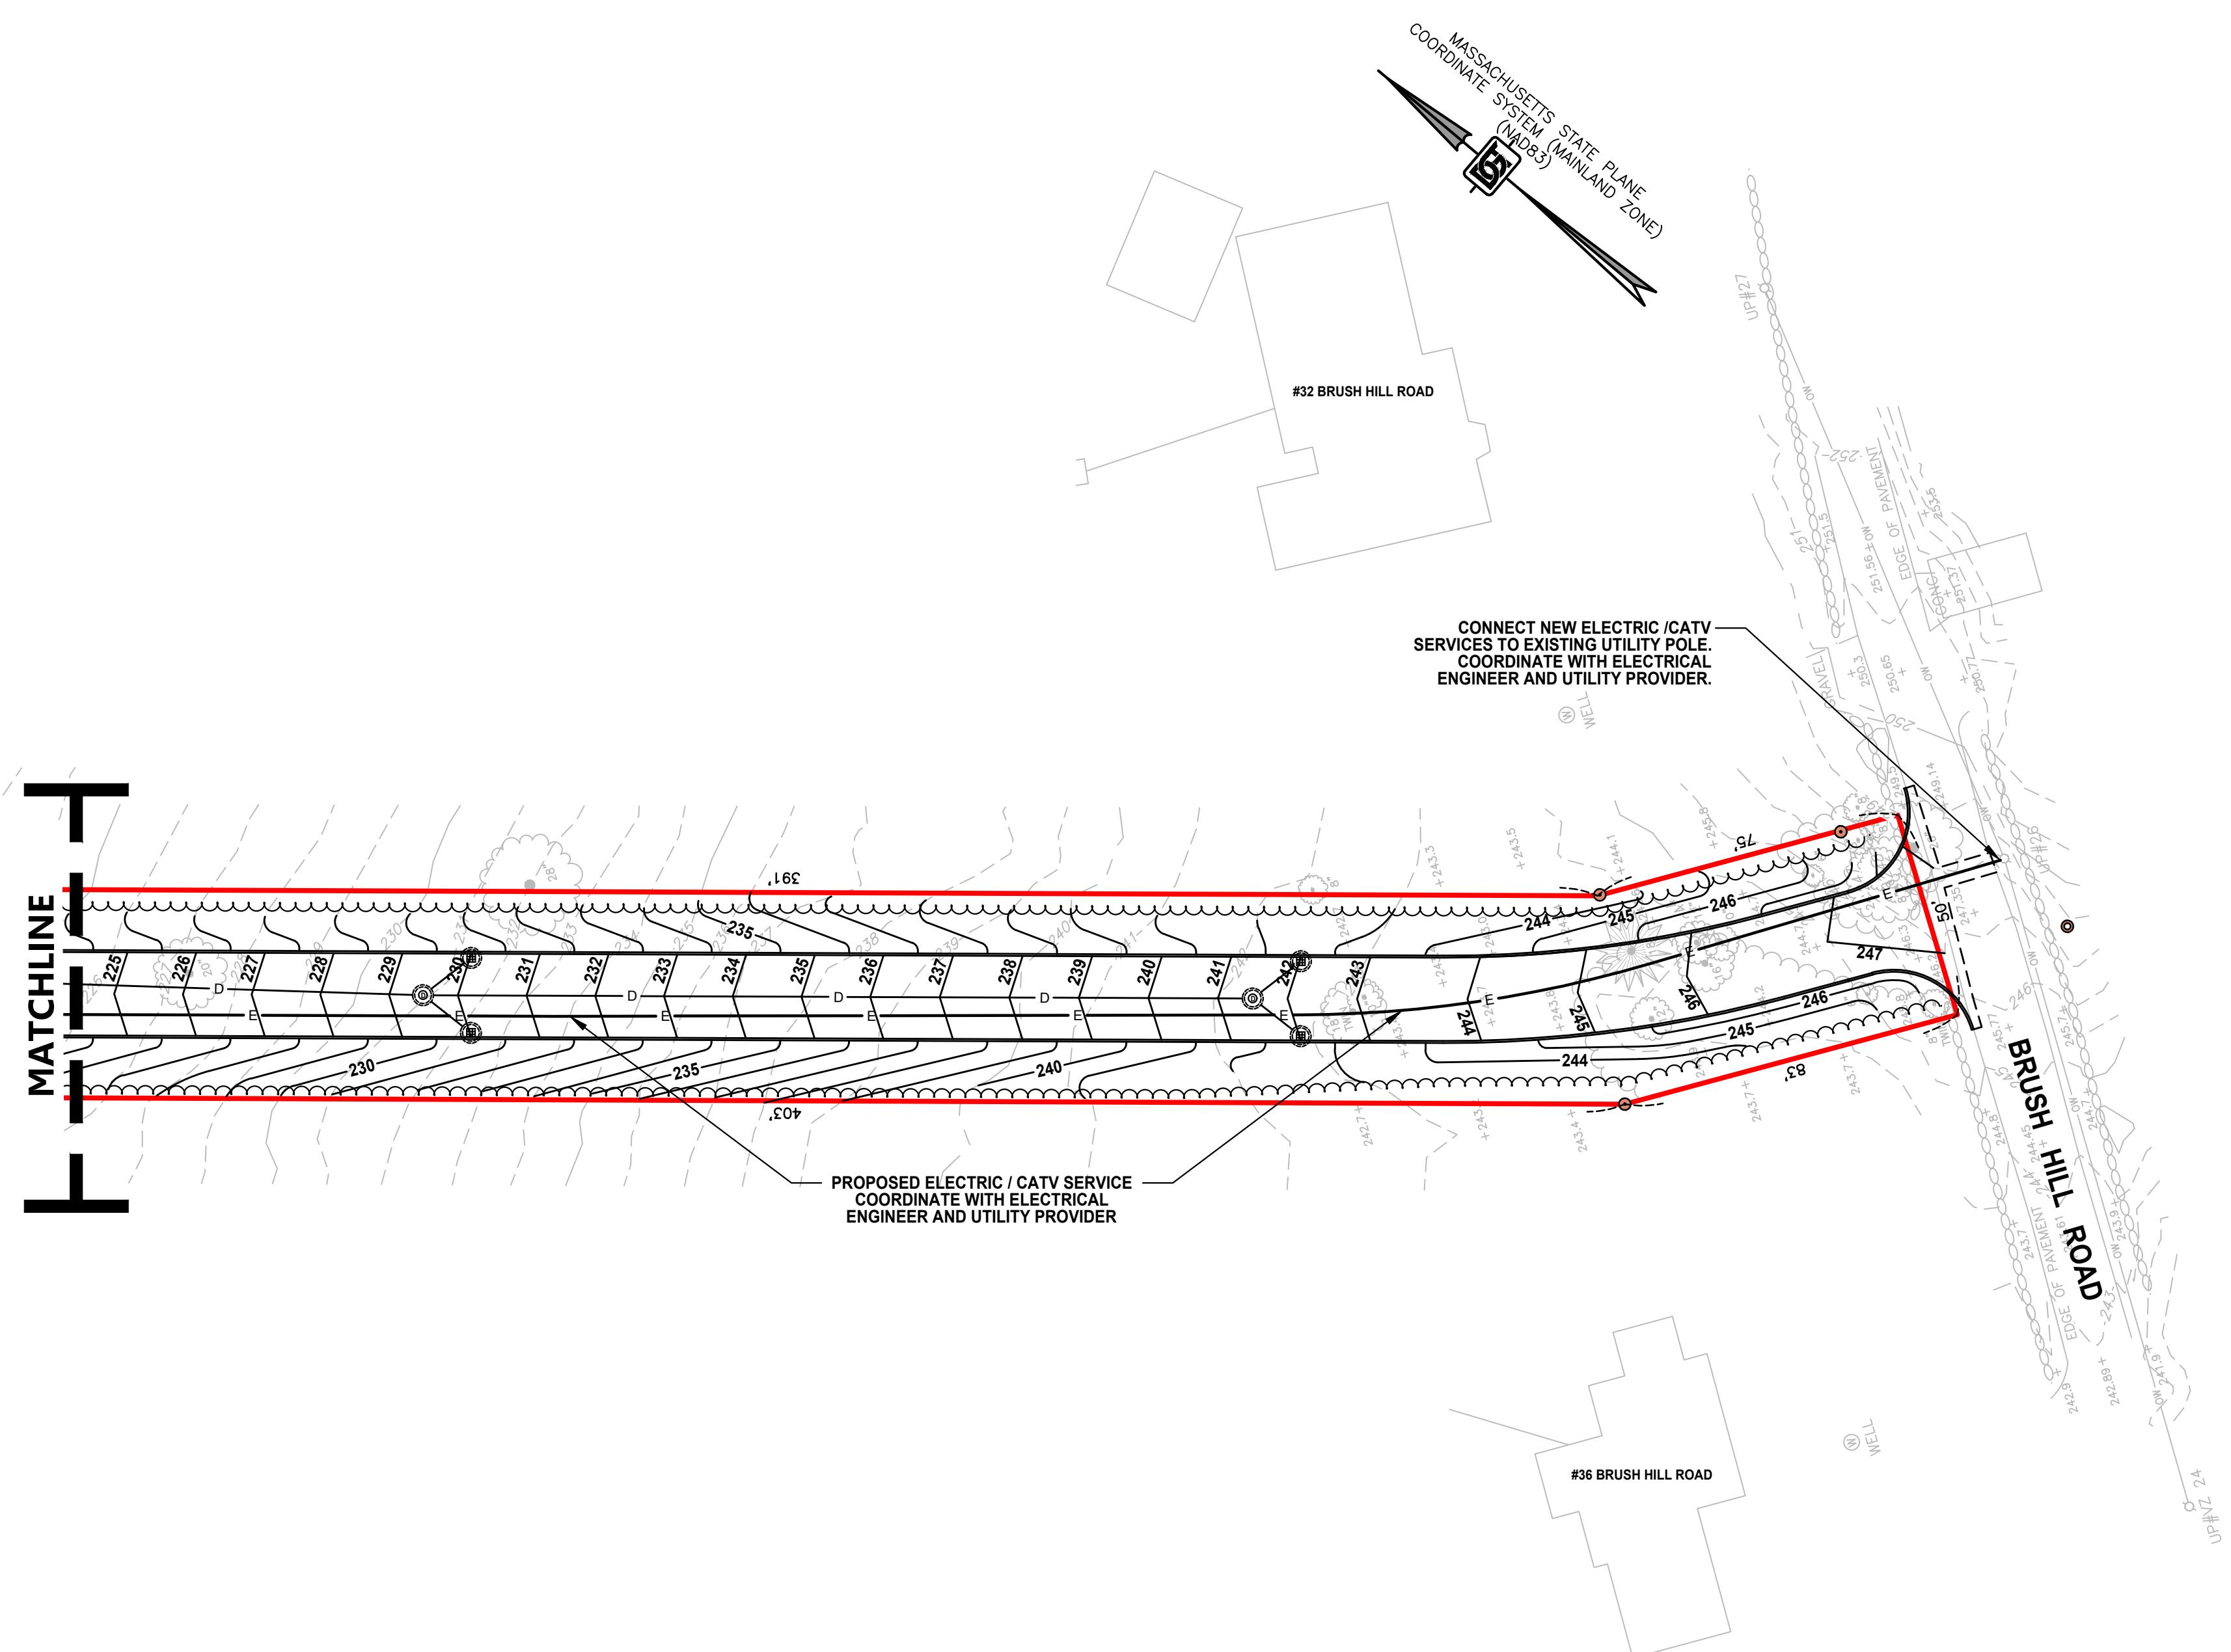

LEGEND	
123—	PROPOSED CONTOUR ELEVATION
D—	PROPOSED DRAIN LINE
RD—	PROPOSED ROOF DRAIN
DM (○)	PROPOSED DRAIN MANHOLE
STU (○)	PROPOSED STORMWATER TREATMENT UNIT
CS (■)	PROPOSED DEEP SUMP CATCH BASIN
AD (●)	PROPOSED AREA DRAIN
OCS (○)	PROPOSED OUTLET CONTROL STRUCTURE
SMH (○)	PROPOSED SEWER MANHOLE
HDPE	HIGH DENSITY POLYETHYLENE
+123.4	PROPOSED SPOT ELEVATION
T.C.=123.4	PROPOSED TOP OF CURB ELEVATION
B.C.=123.4	PROPOSED BOTTOM OF CURB ELEVATION
T.W.=123.4	PROPOSED TOP OF WALL ELEVATION
B.W.=123.4	PROPOSED BOTTOM OF WALL ELEVATION

34 BRUSH HILL ROAD
SHERBORN, MA 01770

SHEET TITLE:









**SITE UTILITIES
PLAN - 02**

SHEET:
12 OF 17

C-12

PROJECT NO.:
F-25889

30 0 15 30 60 120
SCALE: 1" = 30'

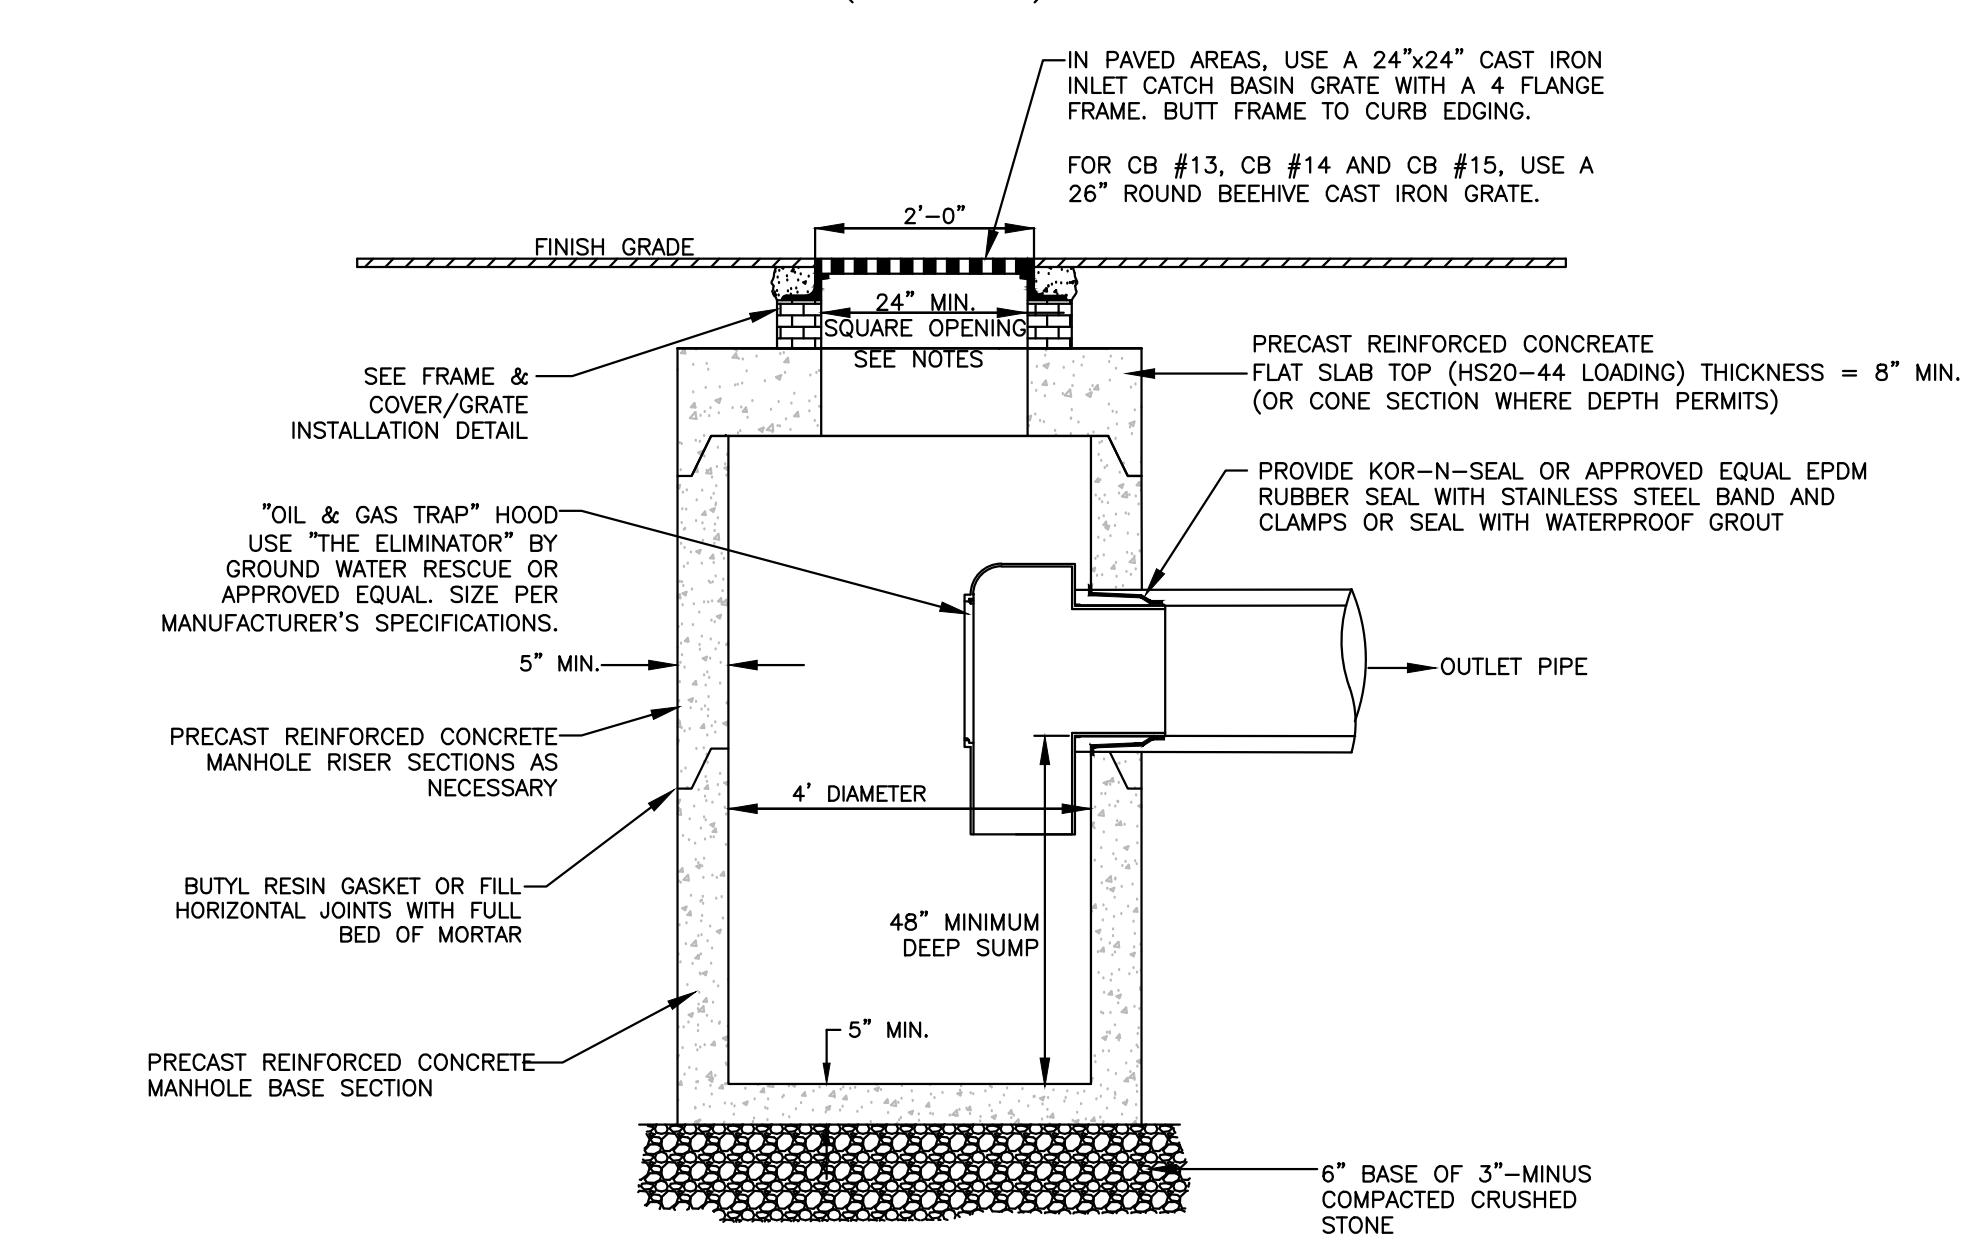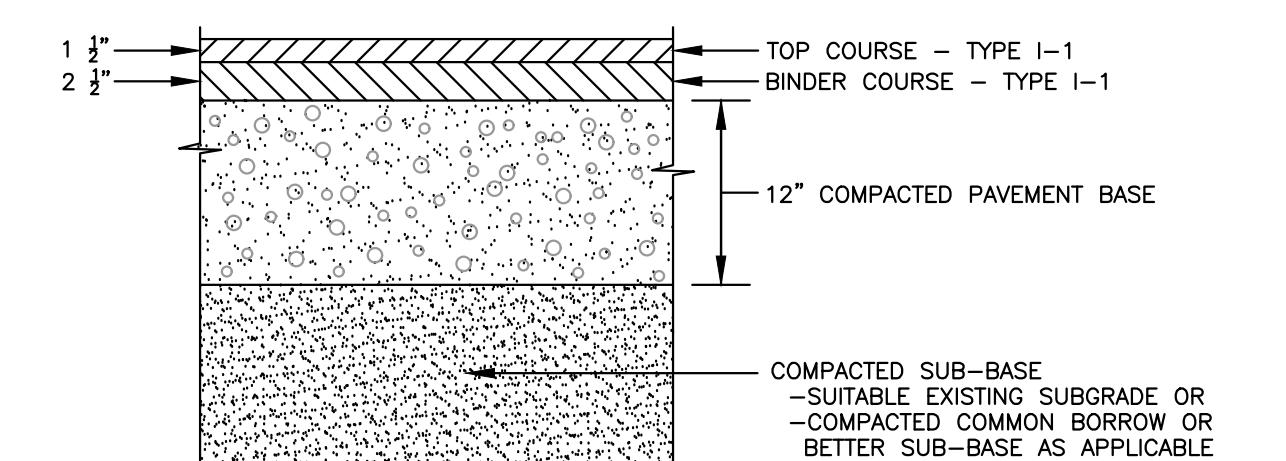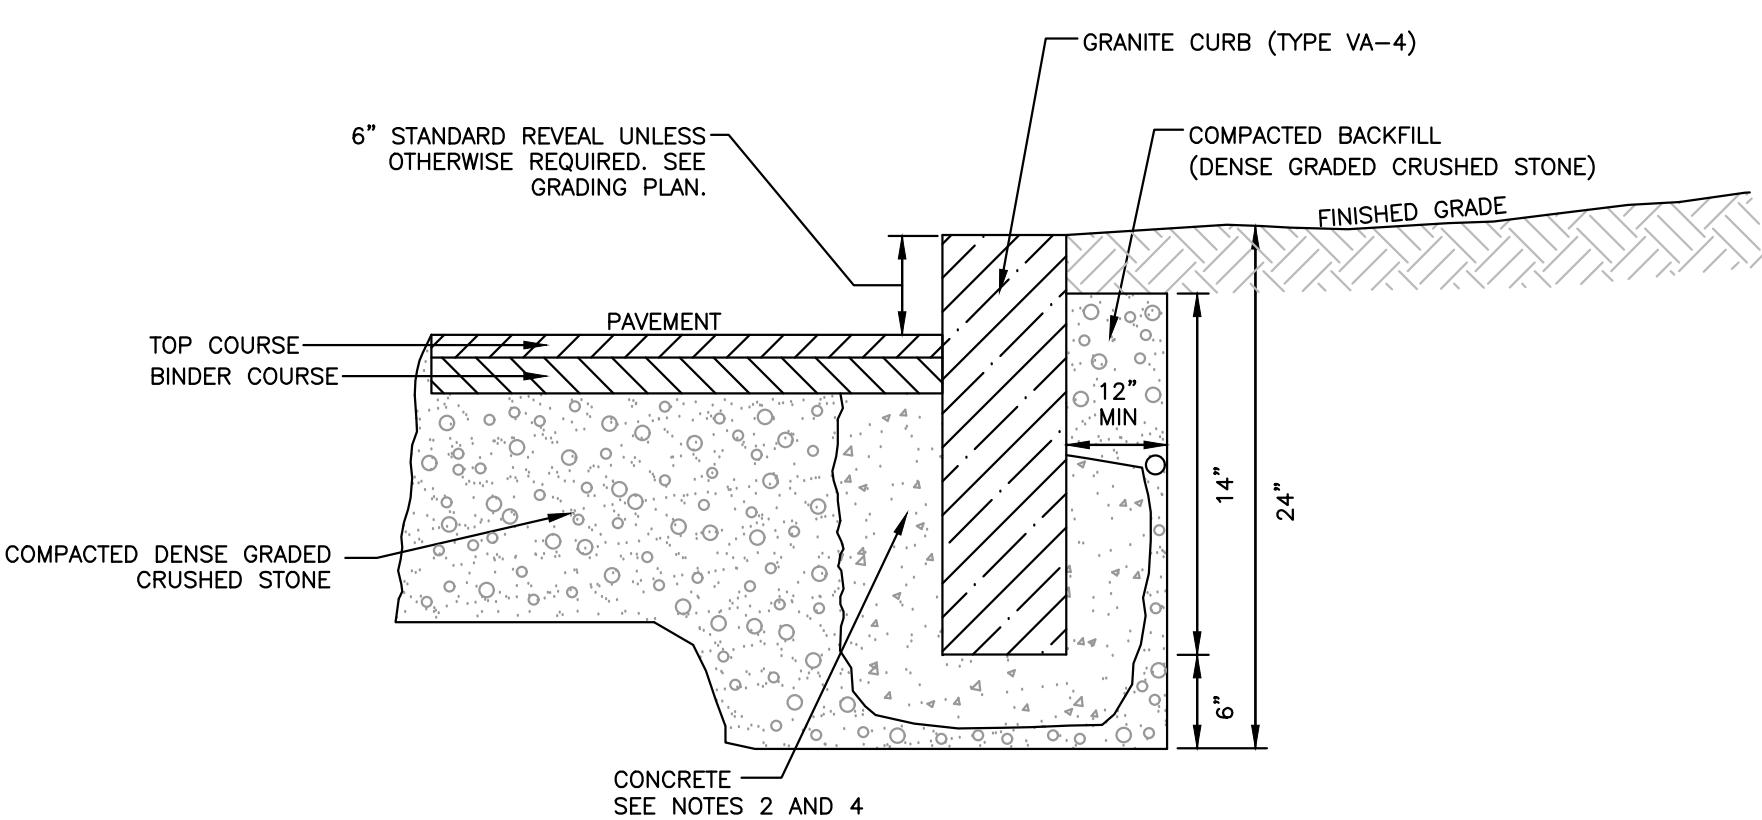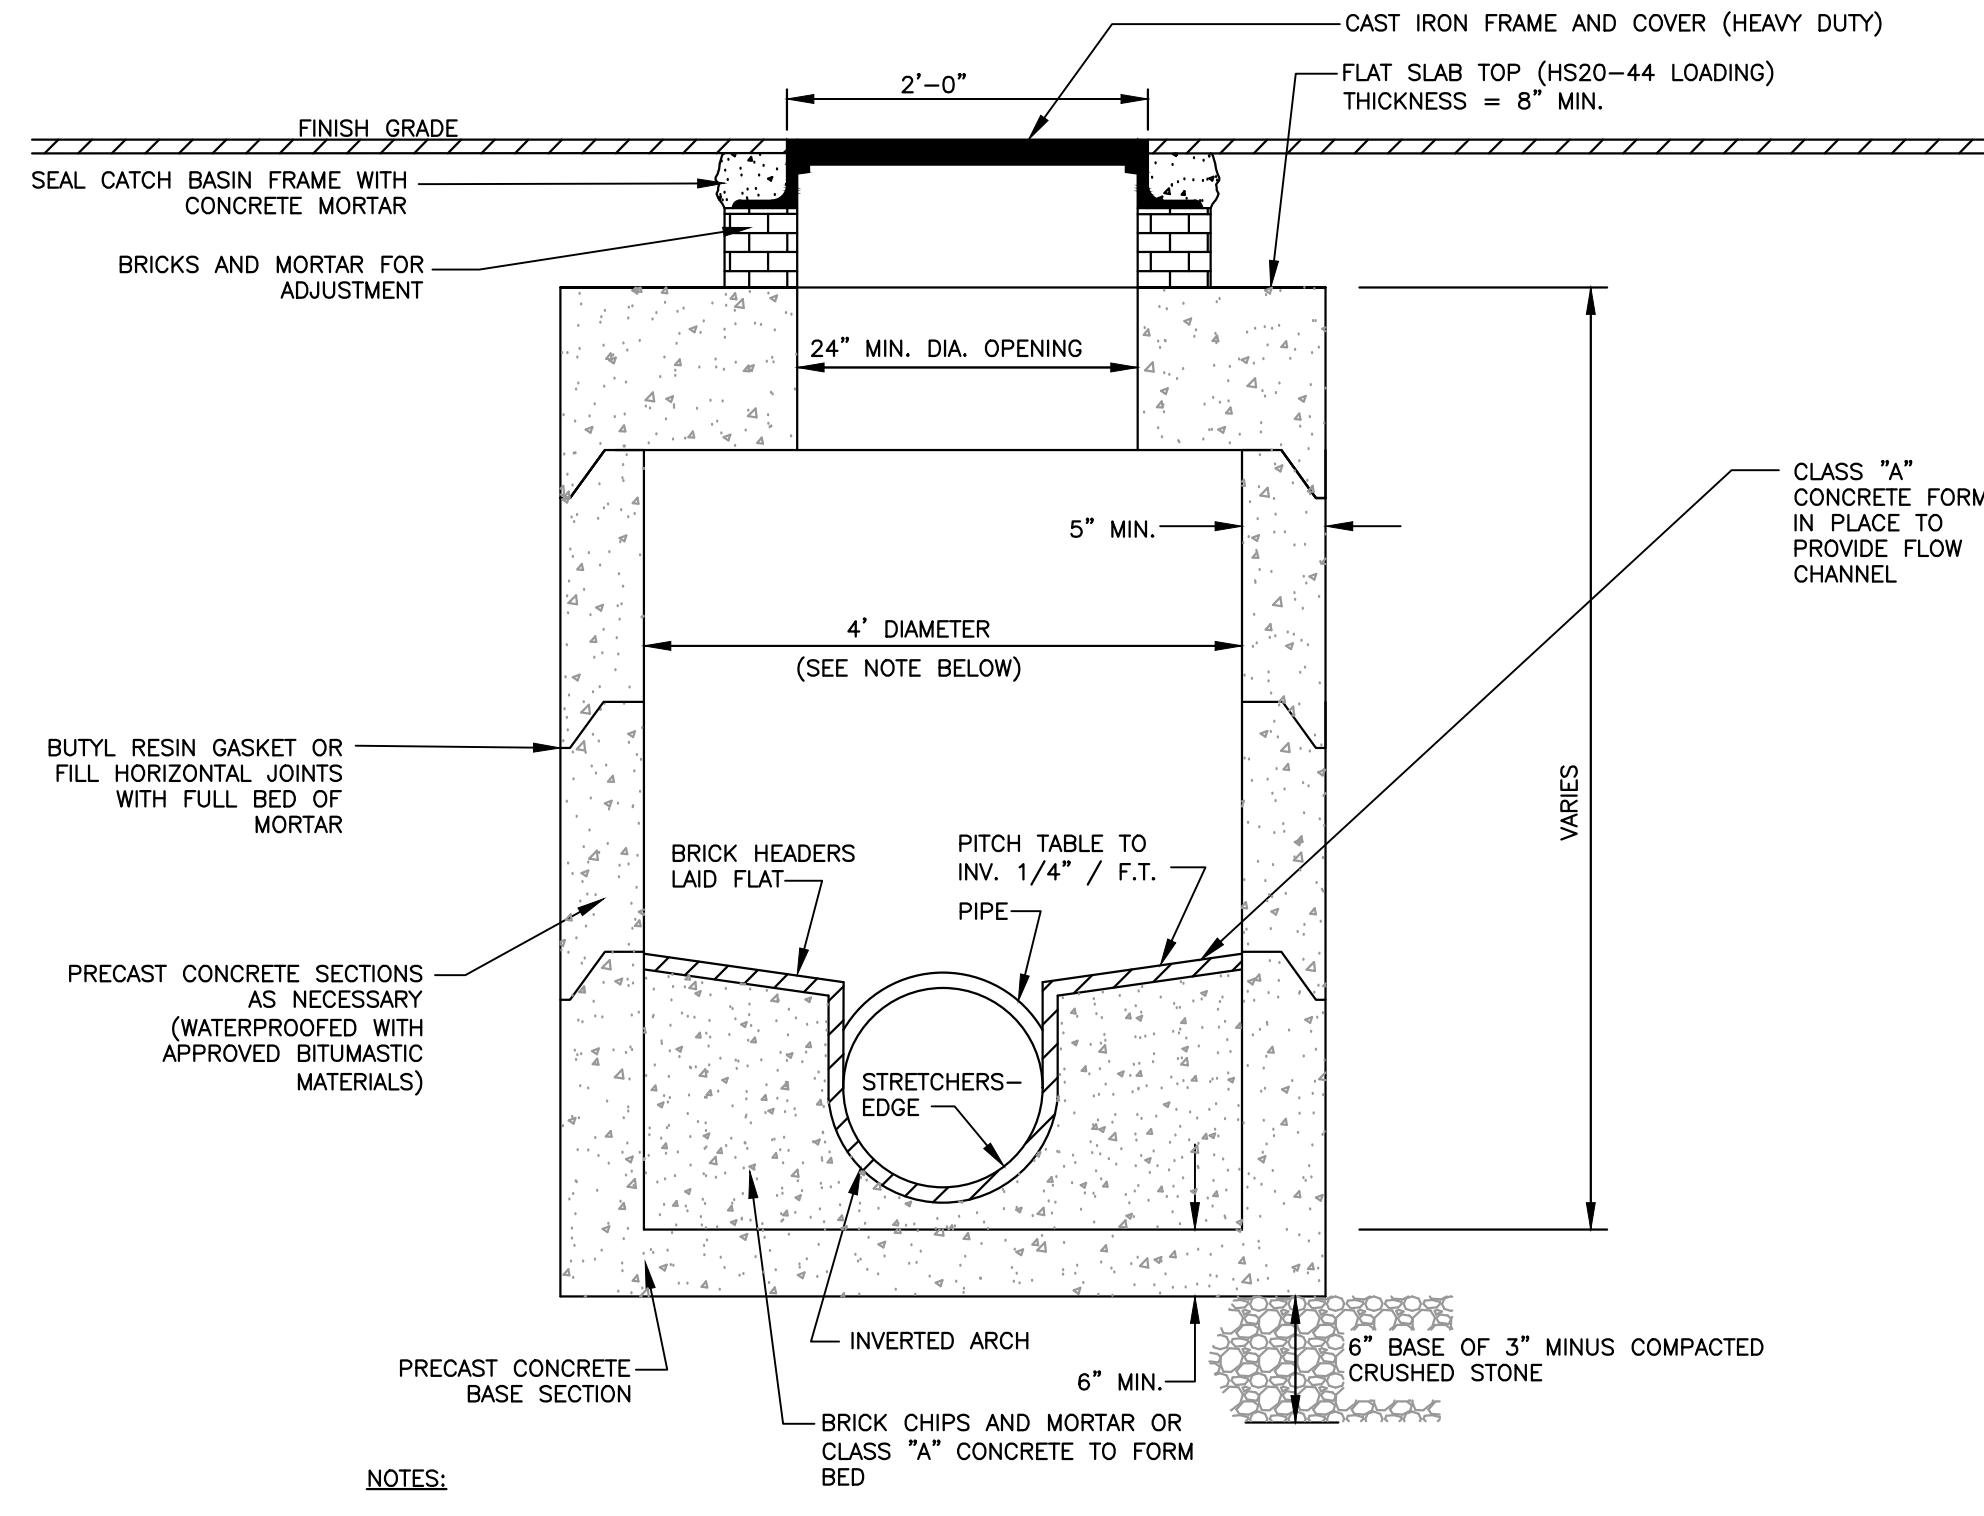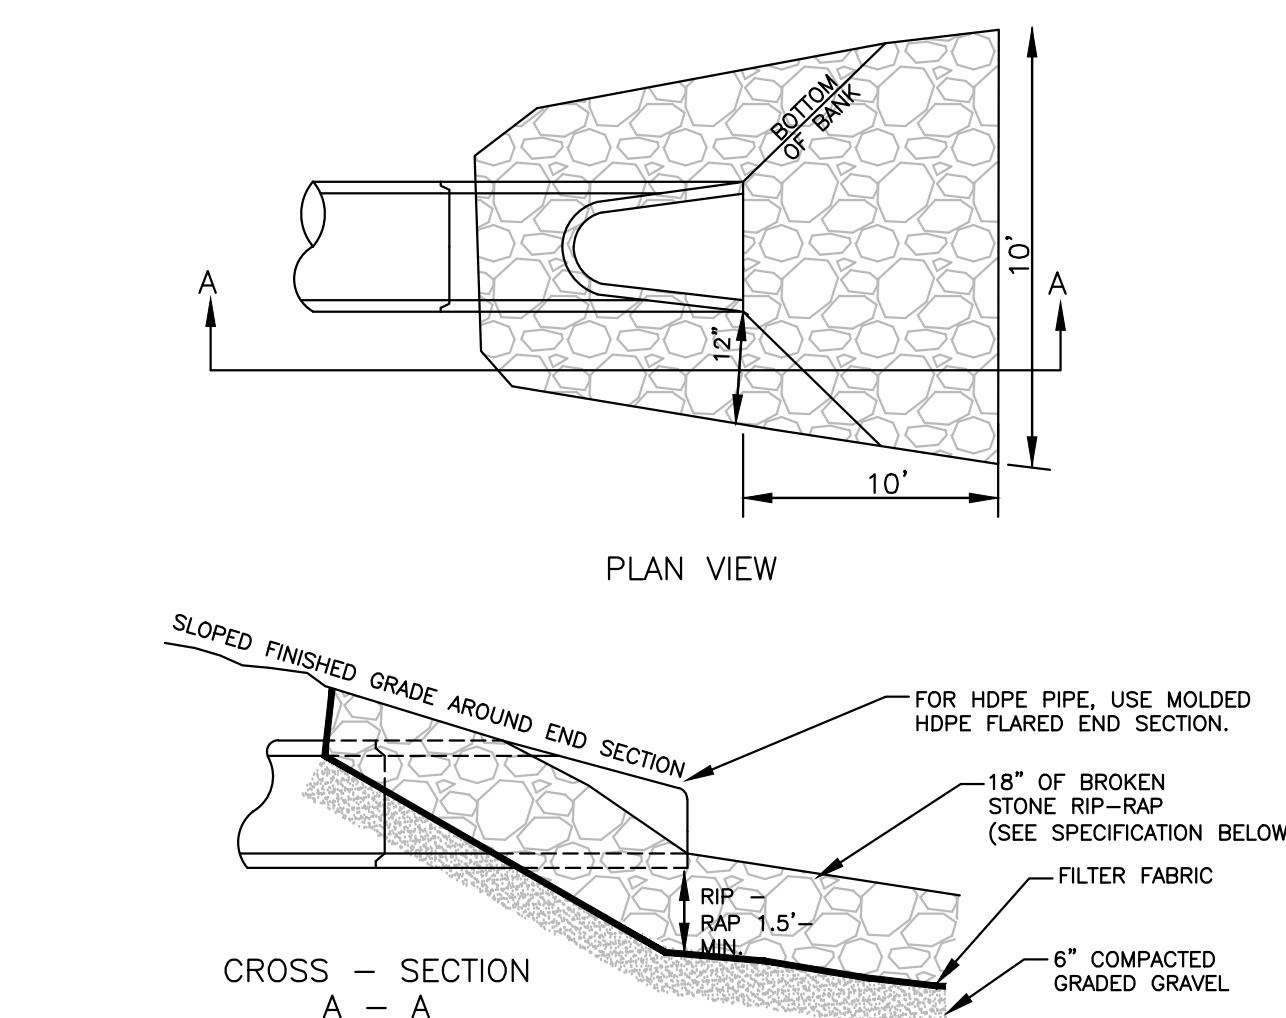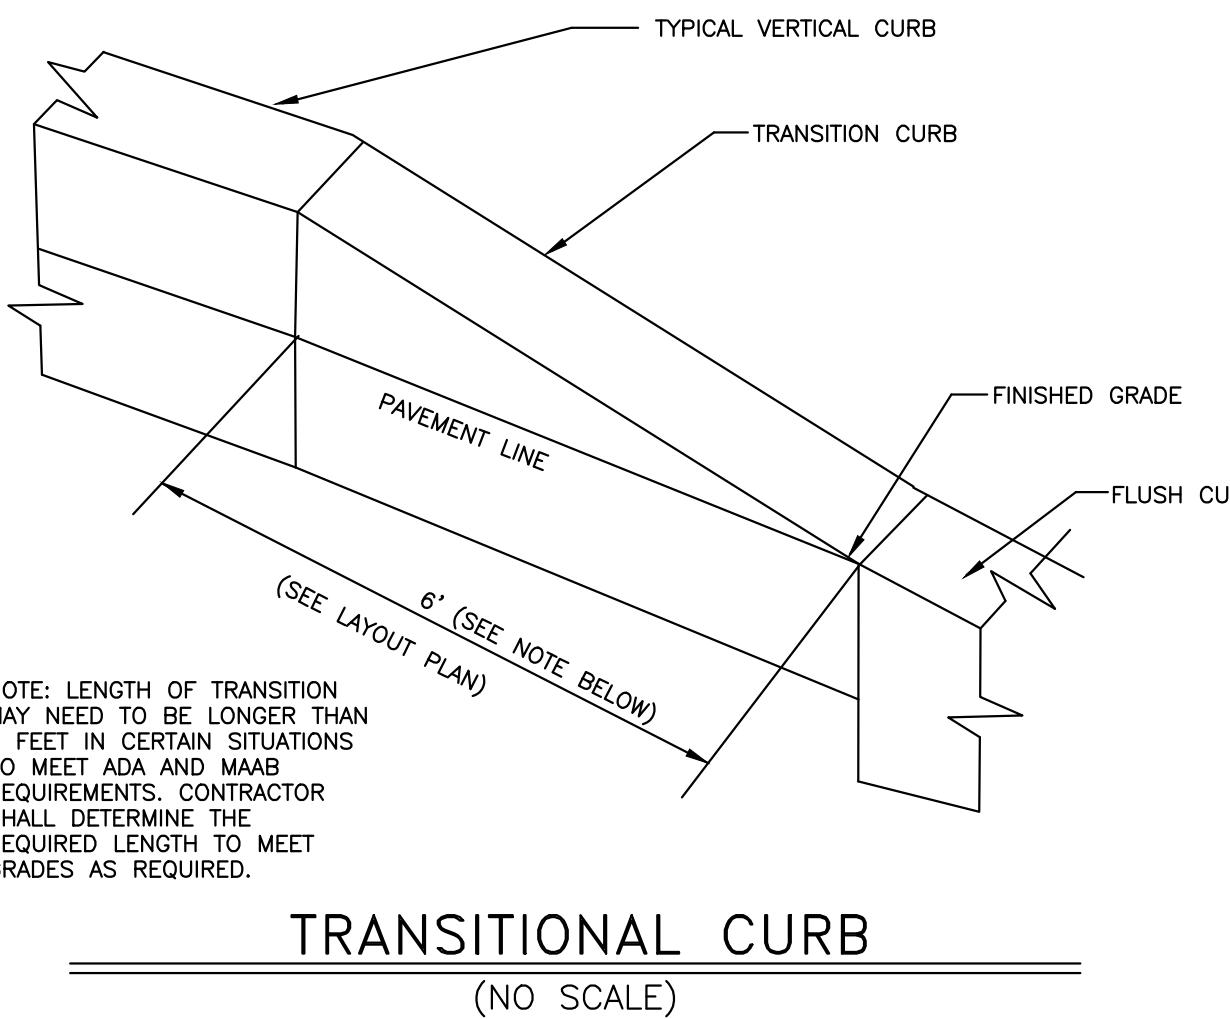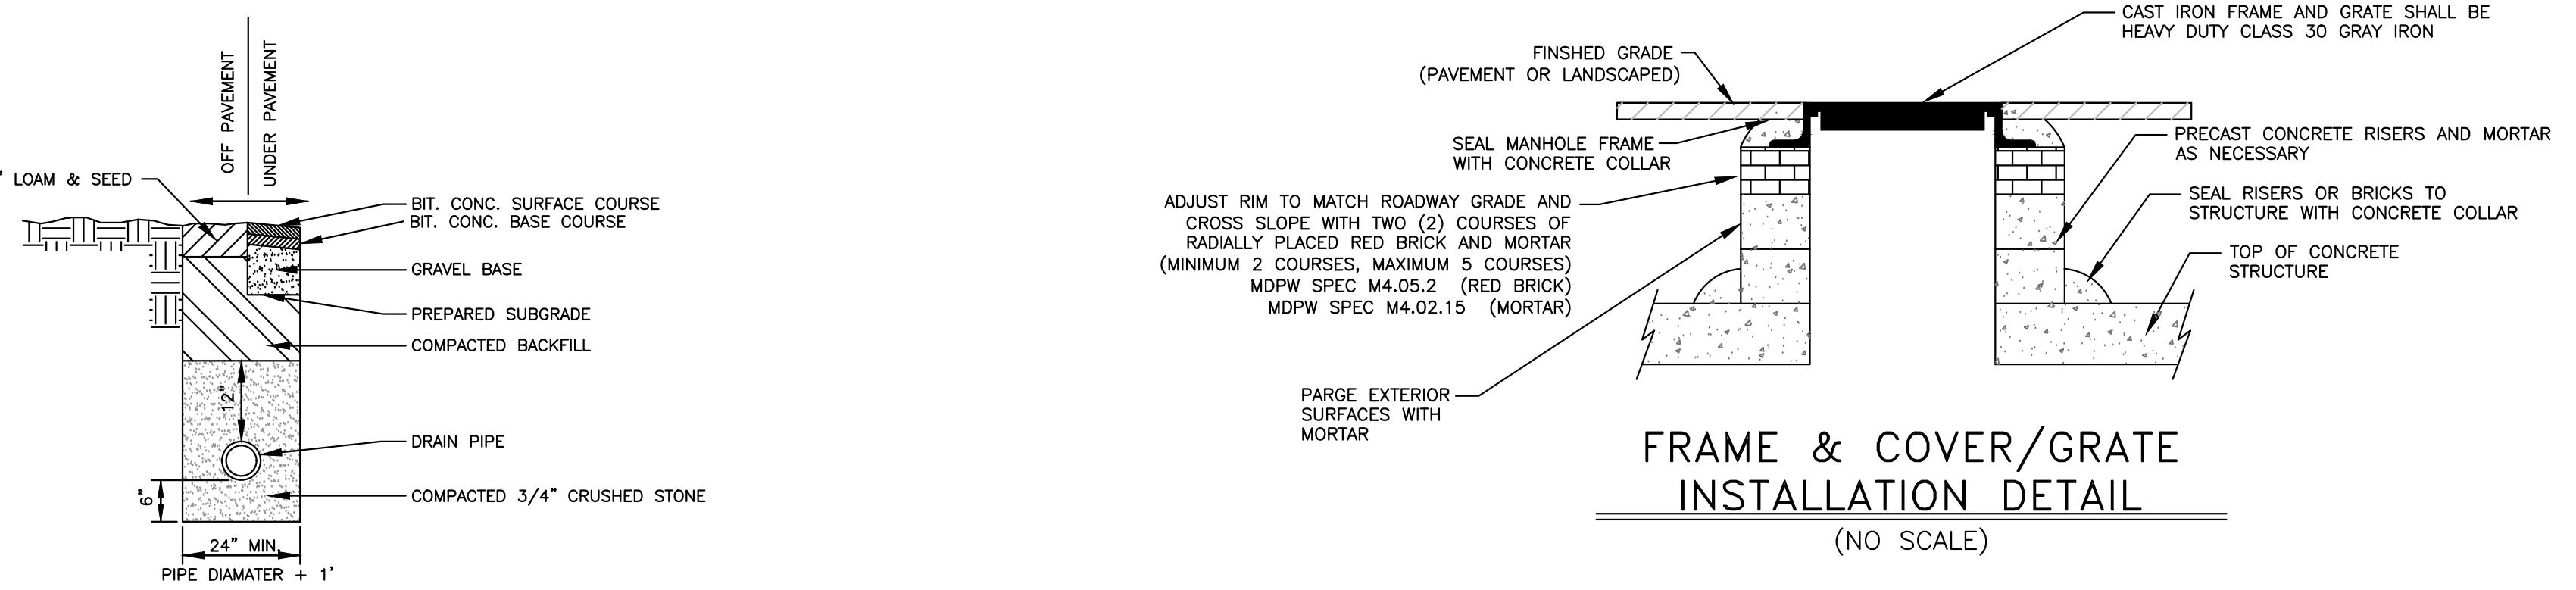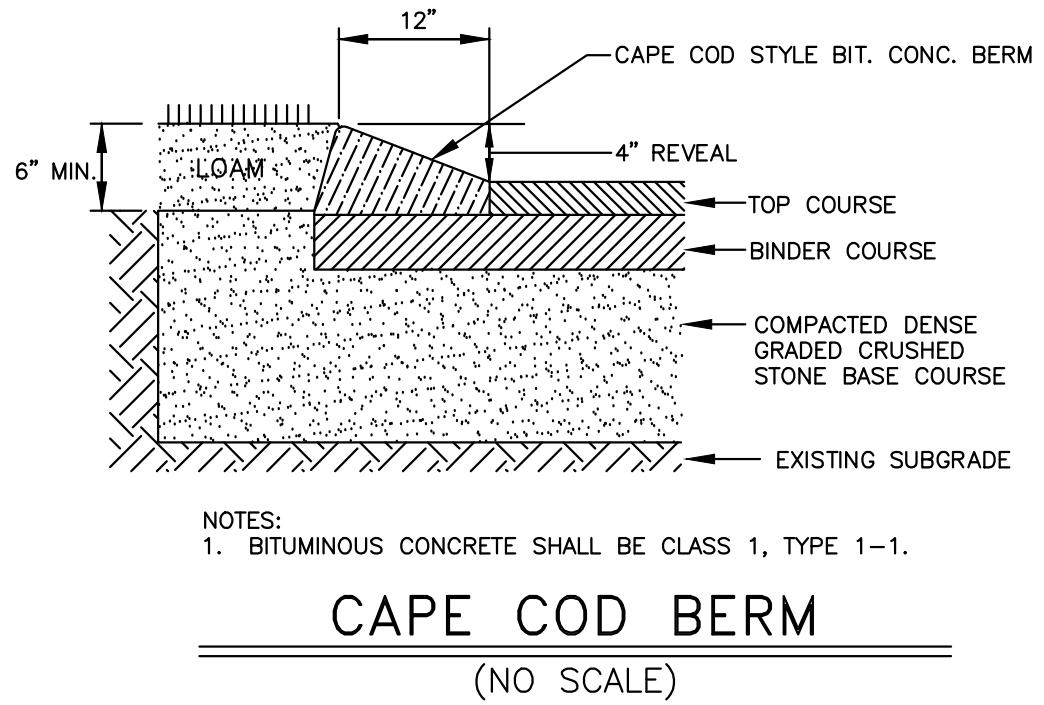

**34 BRUSH HILL ROAD
SHERBORN, MA 01770**

SHEET TITLE:

SITE DETAILS - 01

SHEET:
13 OF 17

C-13

PROJECT NO.:
F-25889

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BFR E.
COREY
CIVIL
No. 48423

Beet E/1/24

2 BEC 9/19/24 PER BOH REVIEW COMMENTS
1 BEC 6/26/24 DESIGN DEVELOPMENT
NO. APP DATE DESCRIPTION

DATE: JUNE 4, 2024

SCALE: AS NOTED

DESIGN: KMR/BEC DRAFTED: KMR CHECKED: BEC

PROJECT TITLE:

**BRUSH HILL
HOMES**

**34 BRUSH HILL ROAD
SHERBORN, MA 01770**

SHEET TITLE:



SITE DETAILS - 01

SHEET:
13 OF 17

C-13

PROJECT NO.:
F-25889

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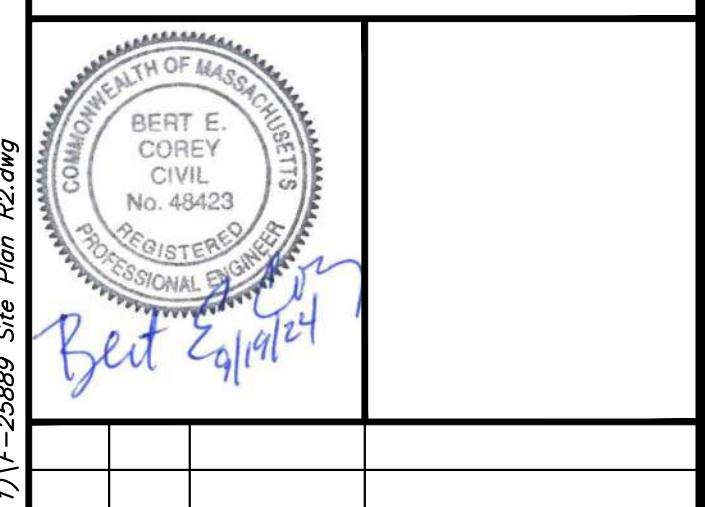
TYPICAL SEWER PIPE BEDDING
 (NO SCALE)

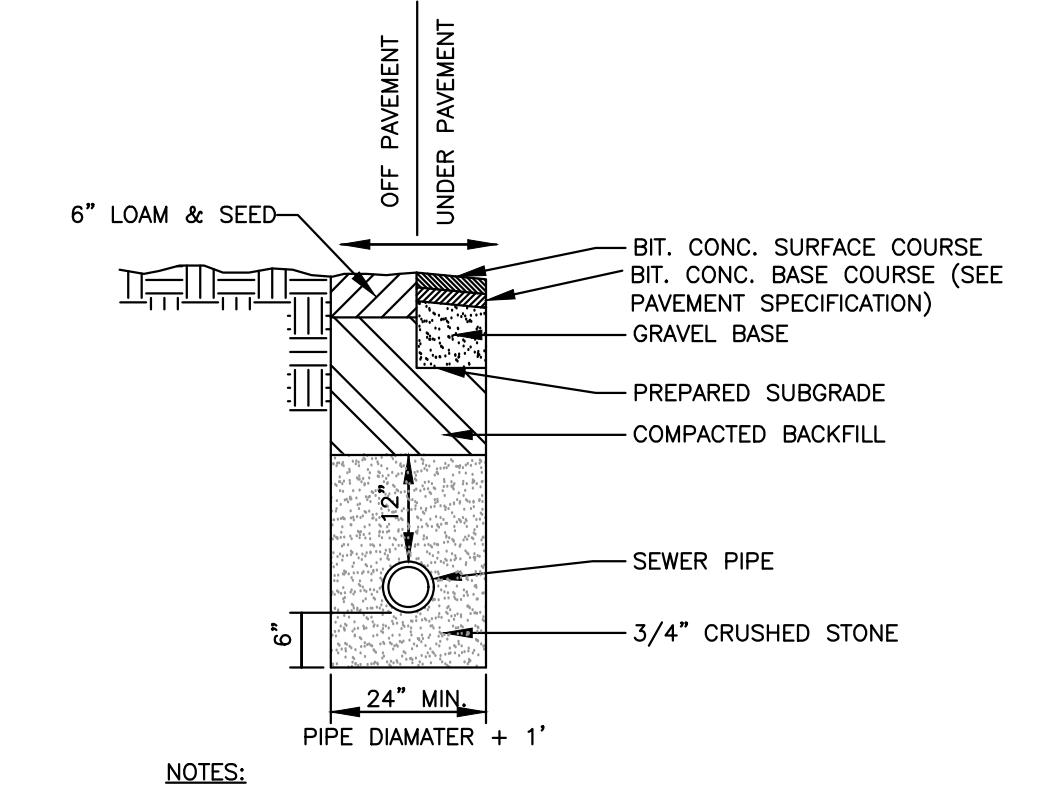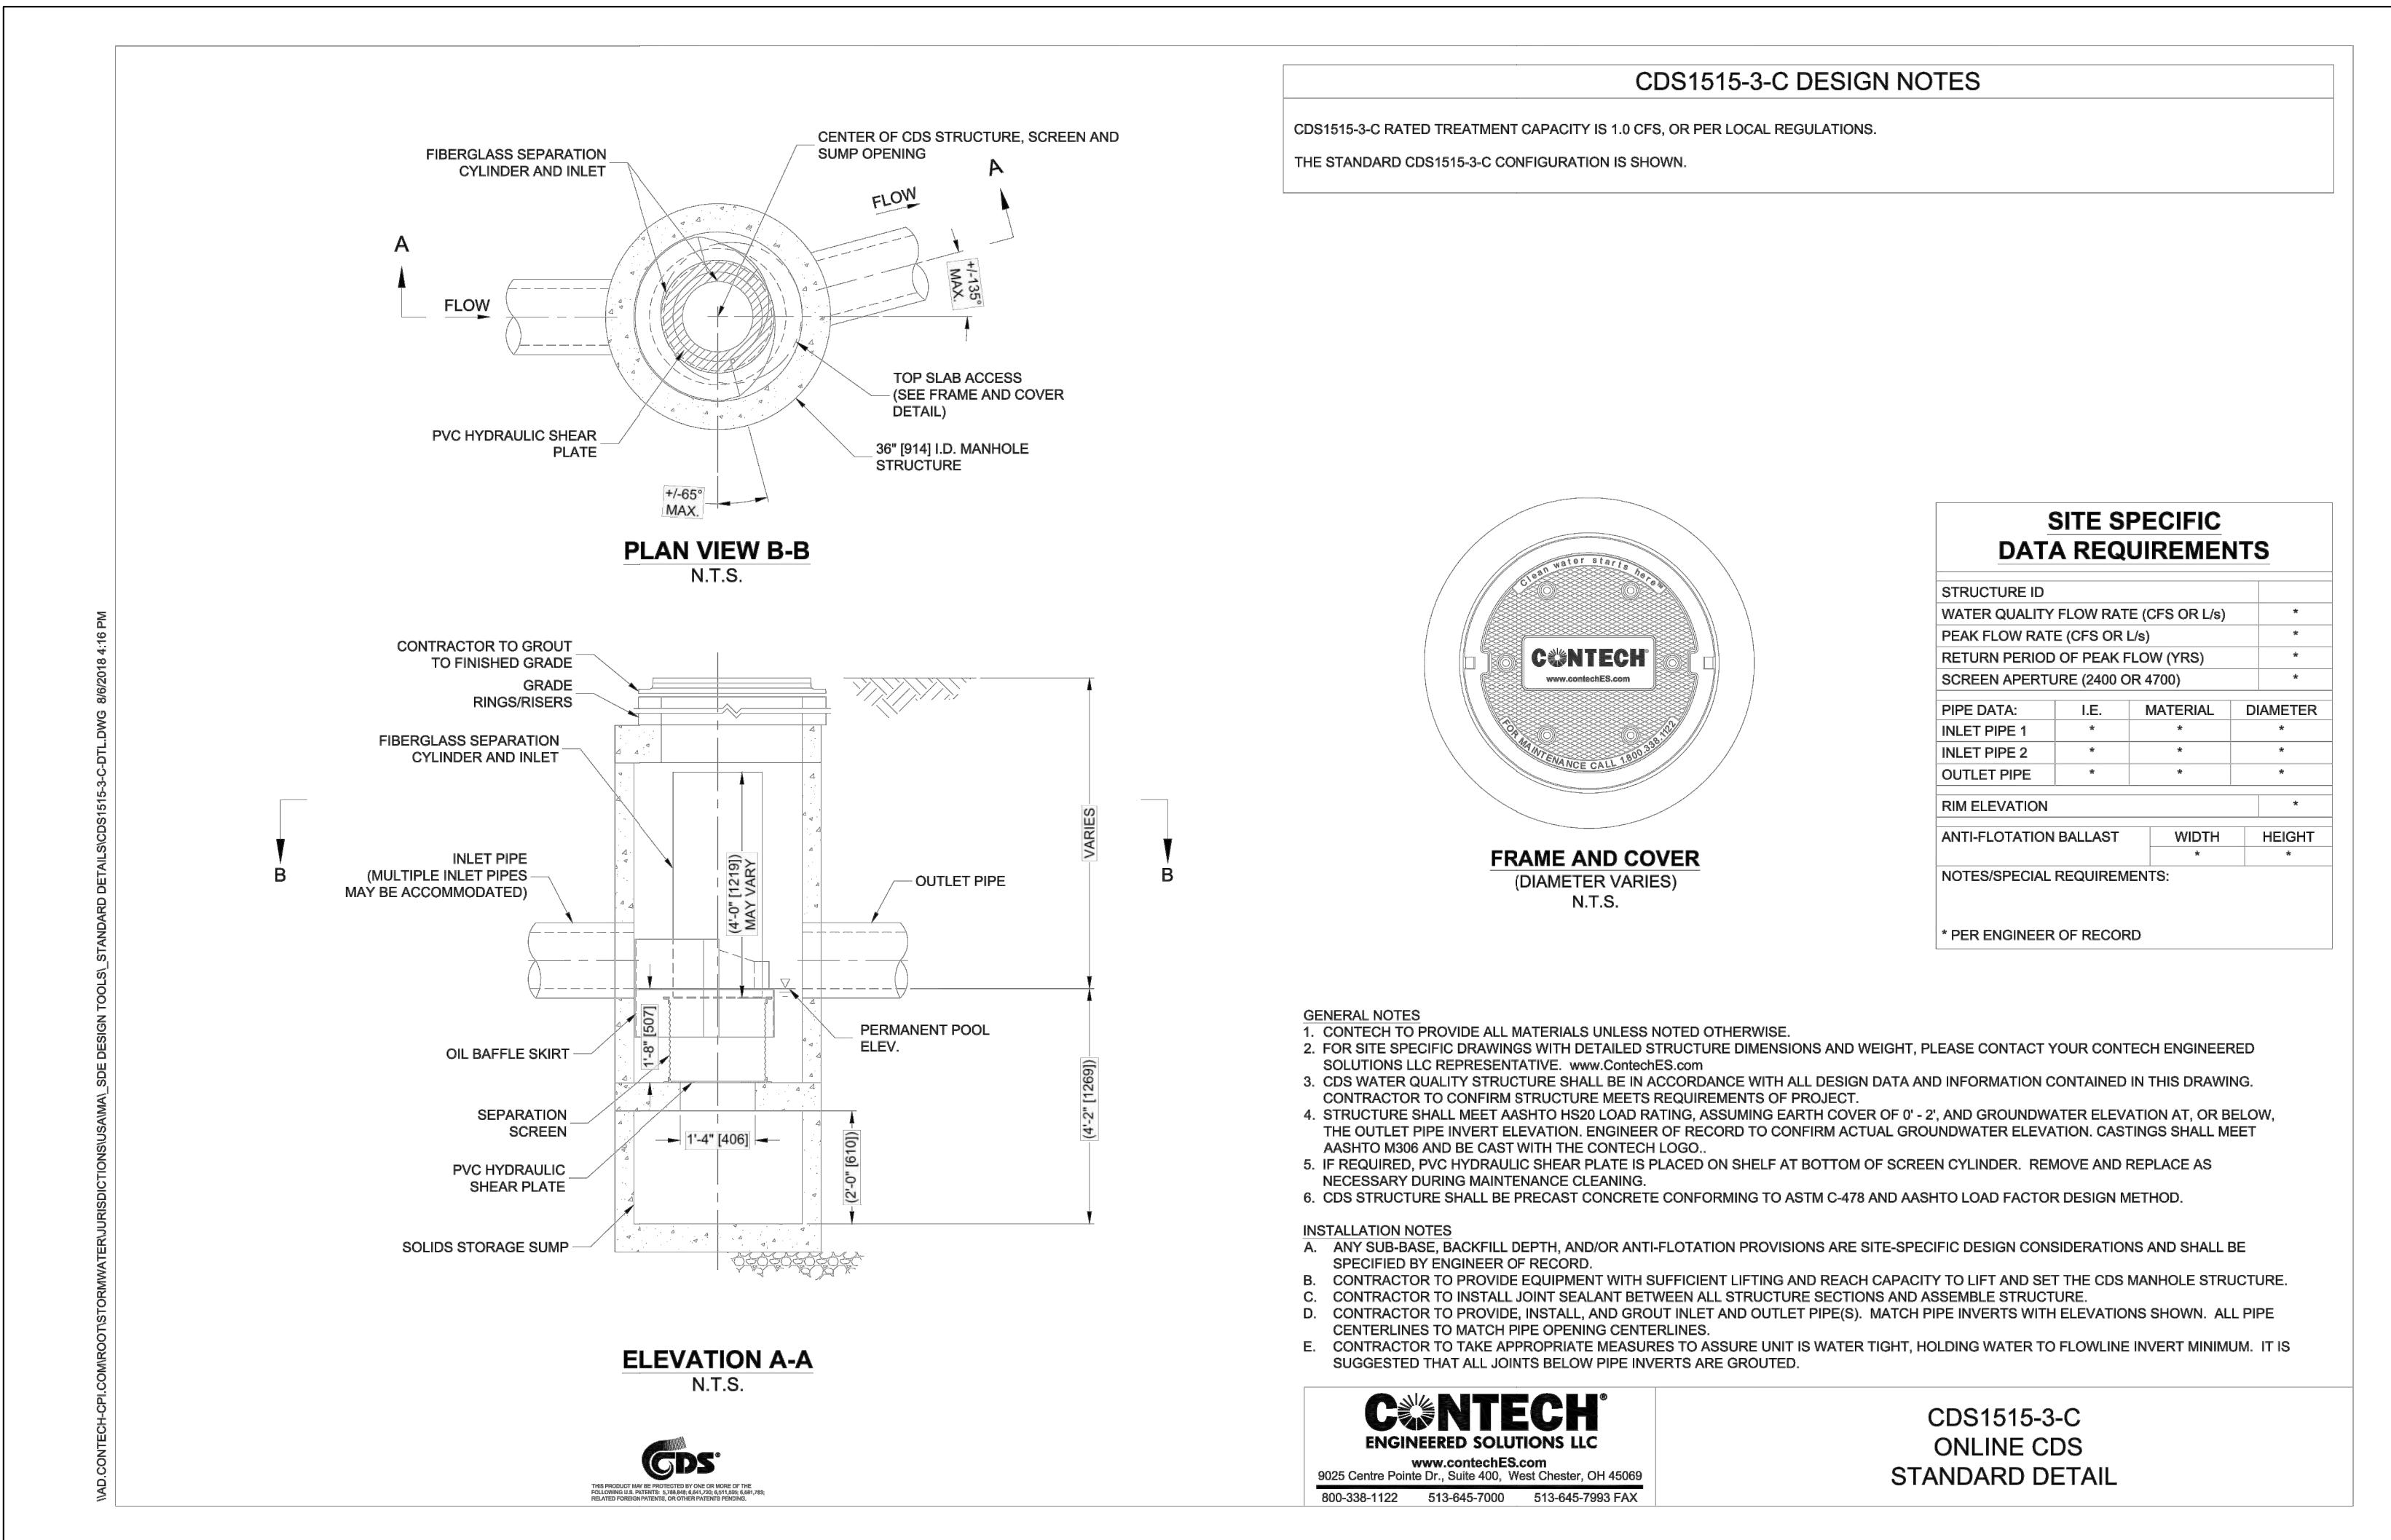APPLICANT:
FENIX PARTNERS BRUSH HILL, LLC
177 LAKE STREET
SHERBORN, MA 01770

OWNER:
FENIX PARTNERS BRUSH HILL, LLC
ref.
MIDDLESEX REGISTRY OF DEEDS
BOOK: 81892 PAGE: 265

PARCEL ID:
MAP 1, LOT 0, BLOCK 18

ISSUED FOR:
COMPREHENSIVE PERMIT APPLICATION



2 BEC 9/19/24 PER BOH REVIEW COMMENTS
 1 BEC 6/26/24 DESIGN DEVELOPMENT
 NO. APP DATE DESCRIPTION

DATE: **JUNE 4, 2024**

SCALE: **AS NOTED**

DESIGN: **KMR/BEC** **DRAFTED:** **KMR** **CHECKED:** **BEC**

PROJECT TITLE:



BRUSH HILL HOMES

34 BRUSH HILL ROAD
SHERBORN, MA 01770




SHEET TITLE:

SITE DETAILS - 02


SHEET: **14 OF 17** **PROJECT NO.:** **F-25889** **C-14**

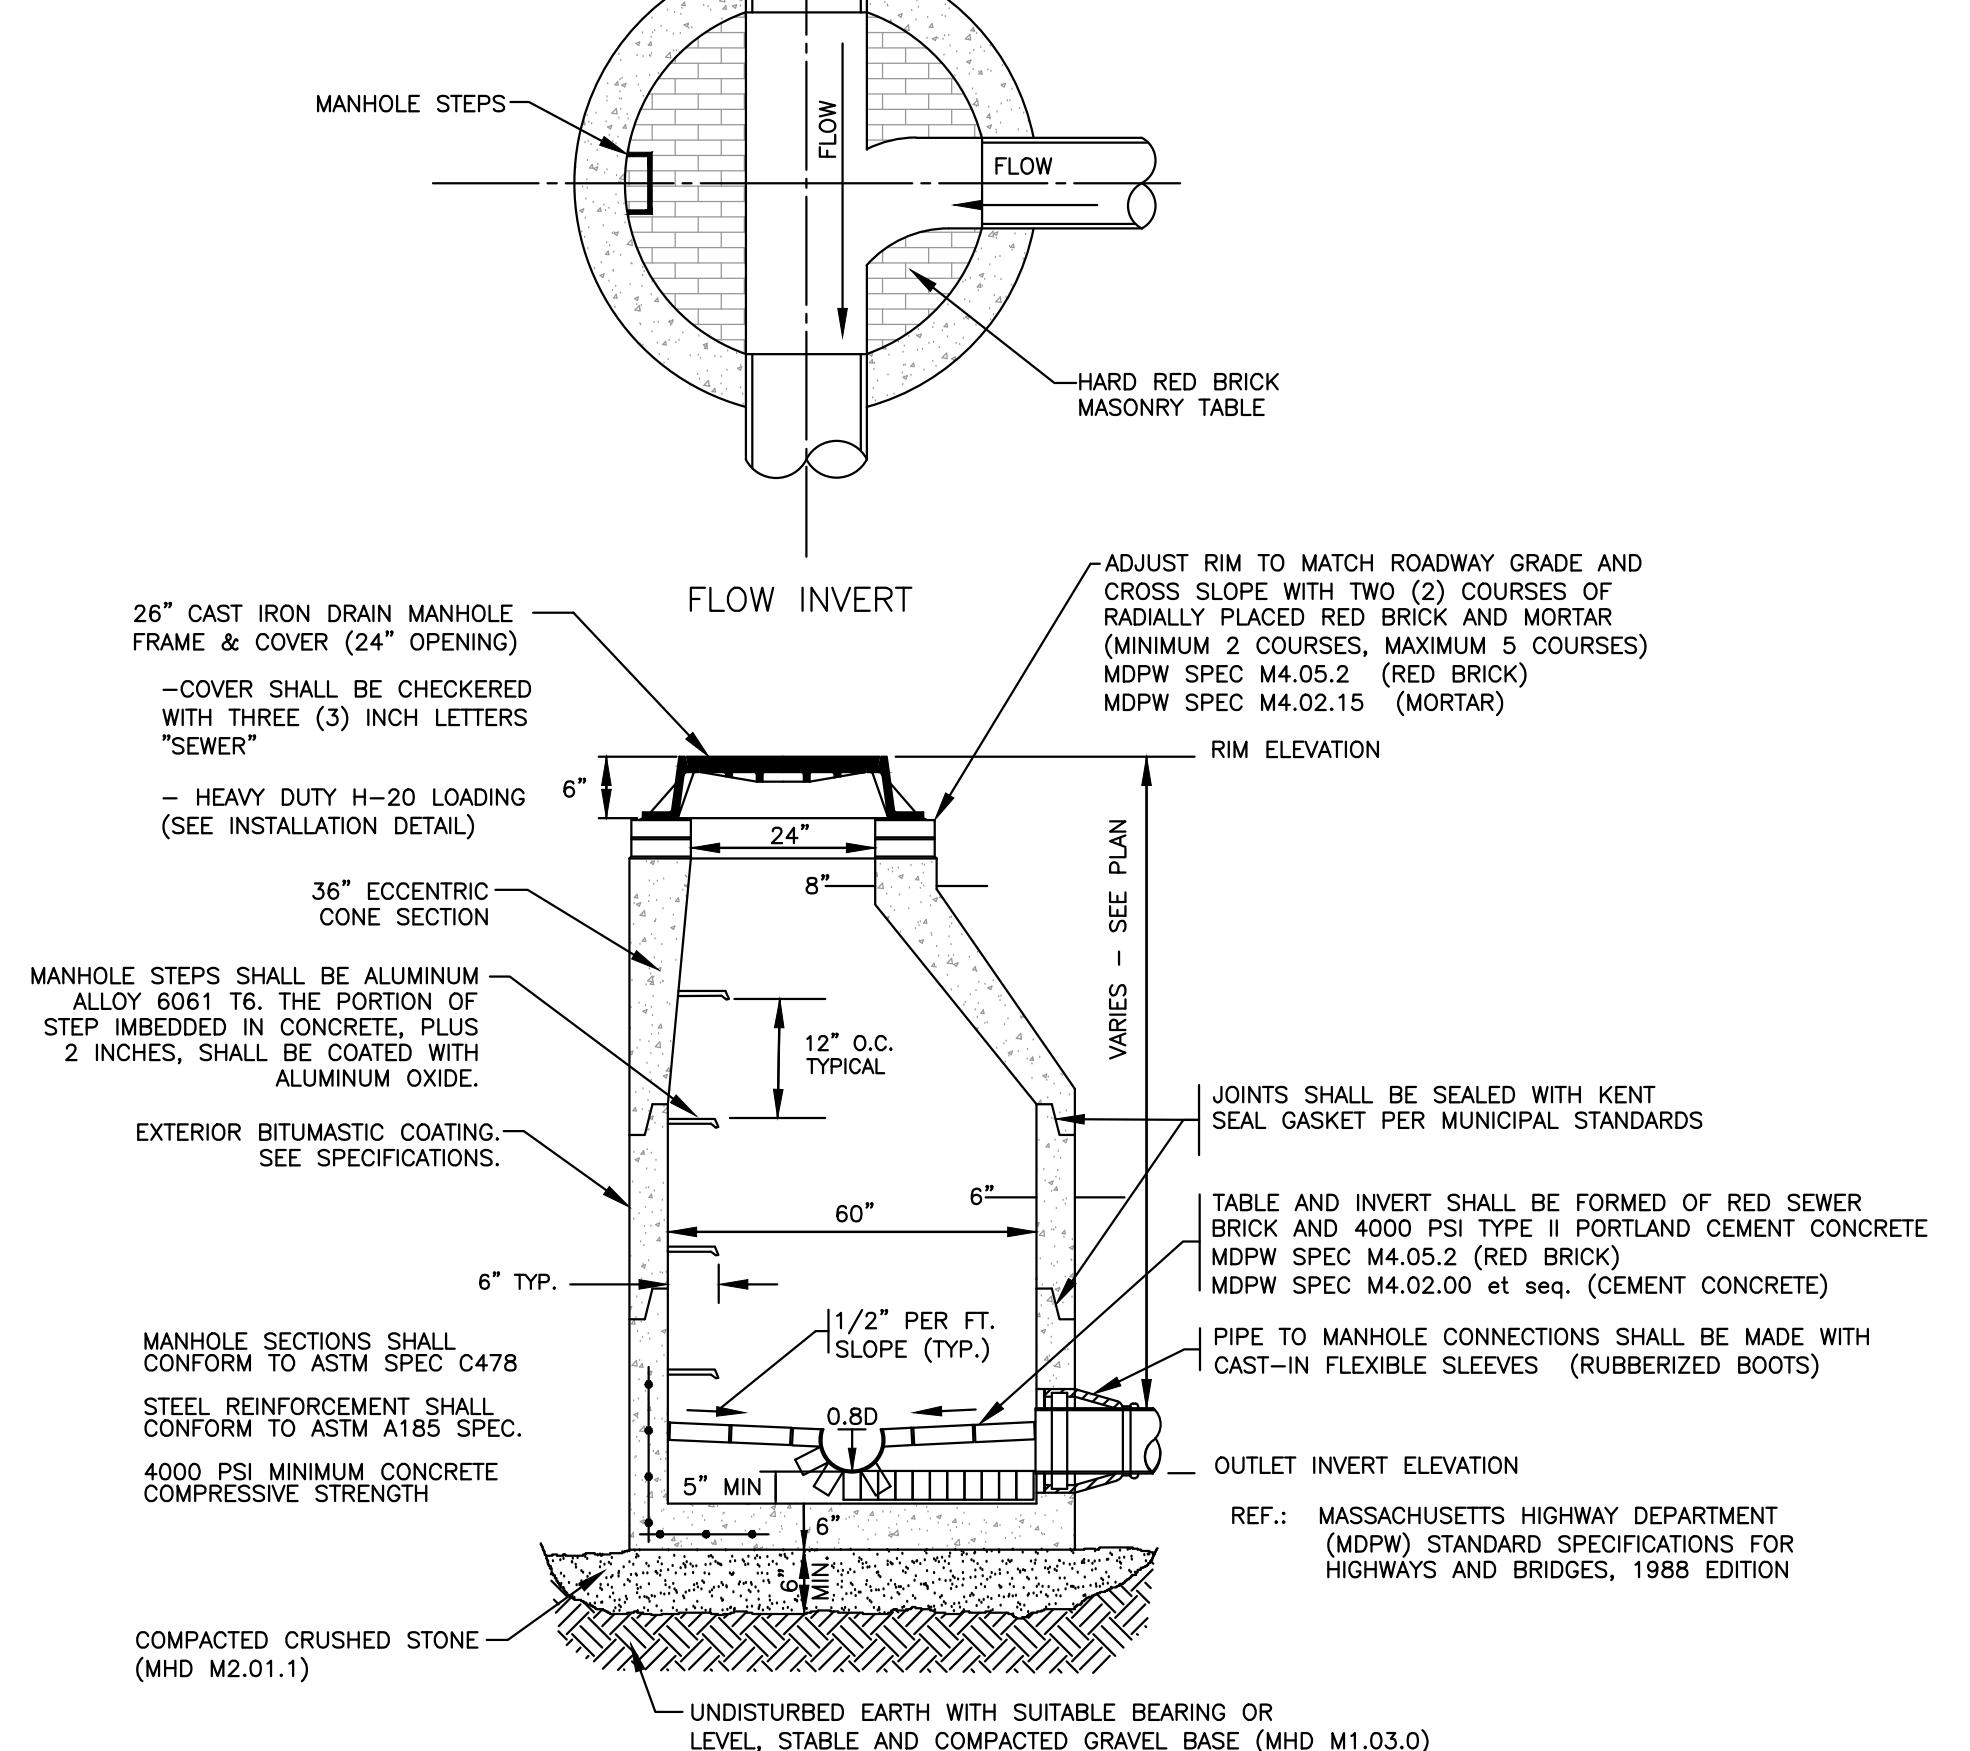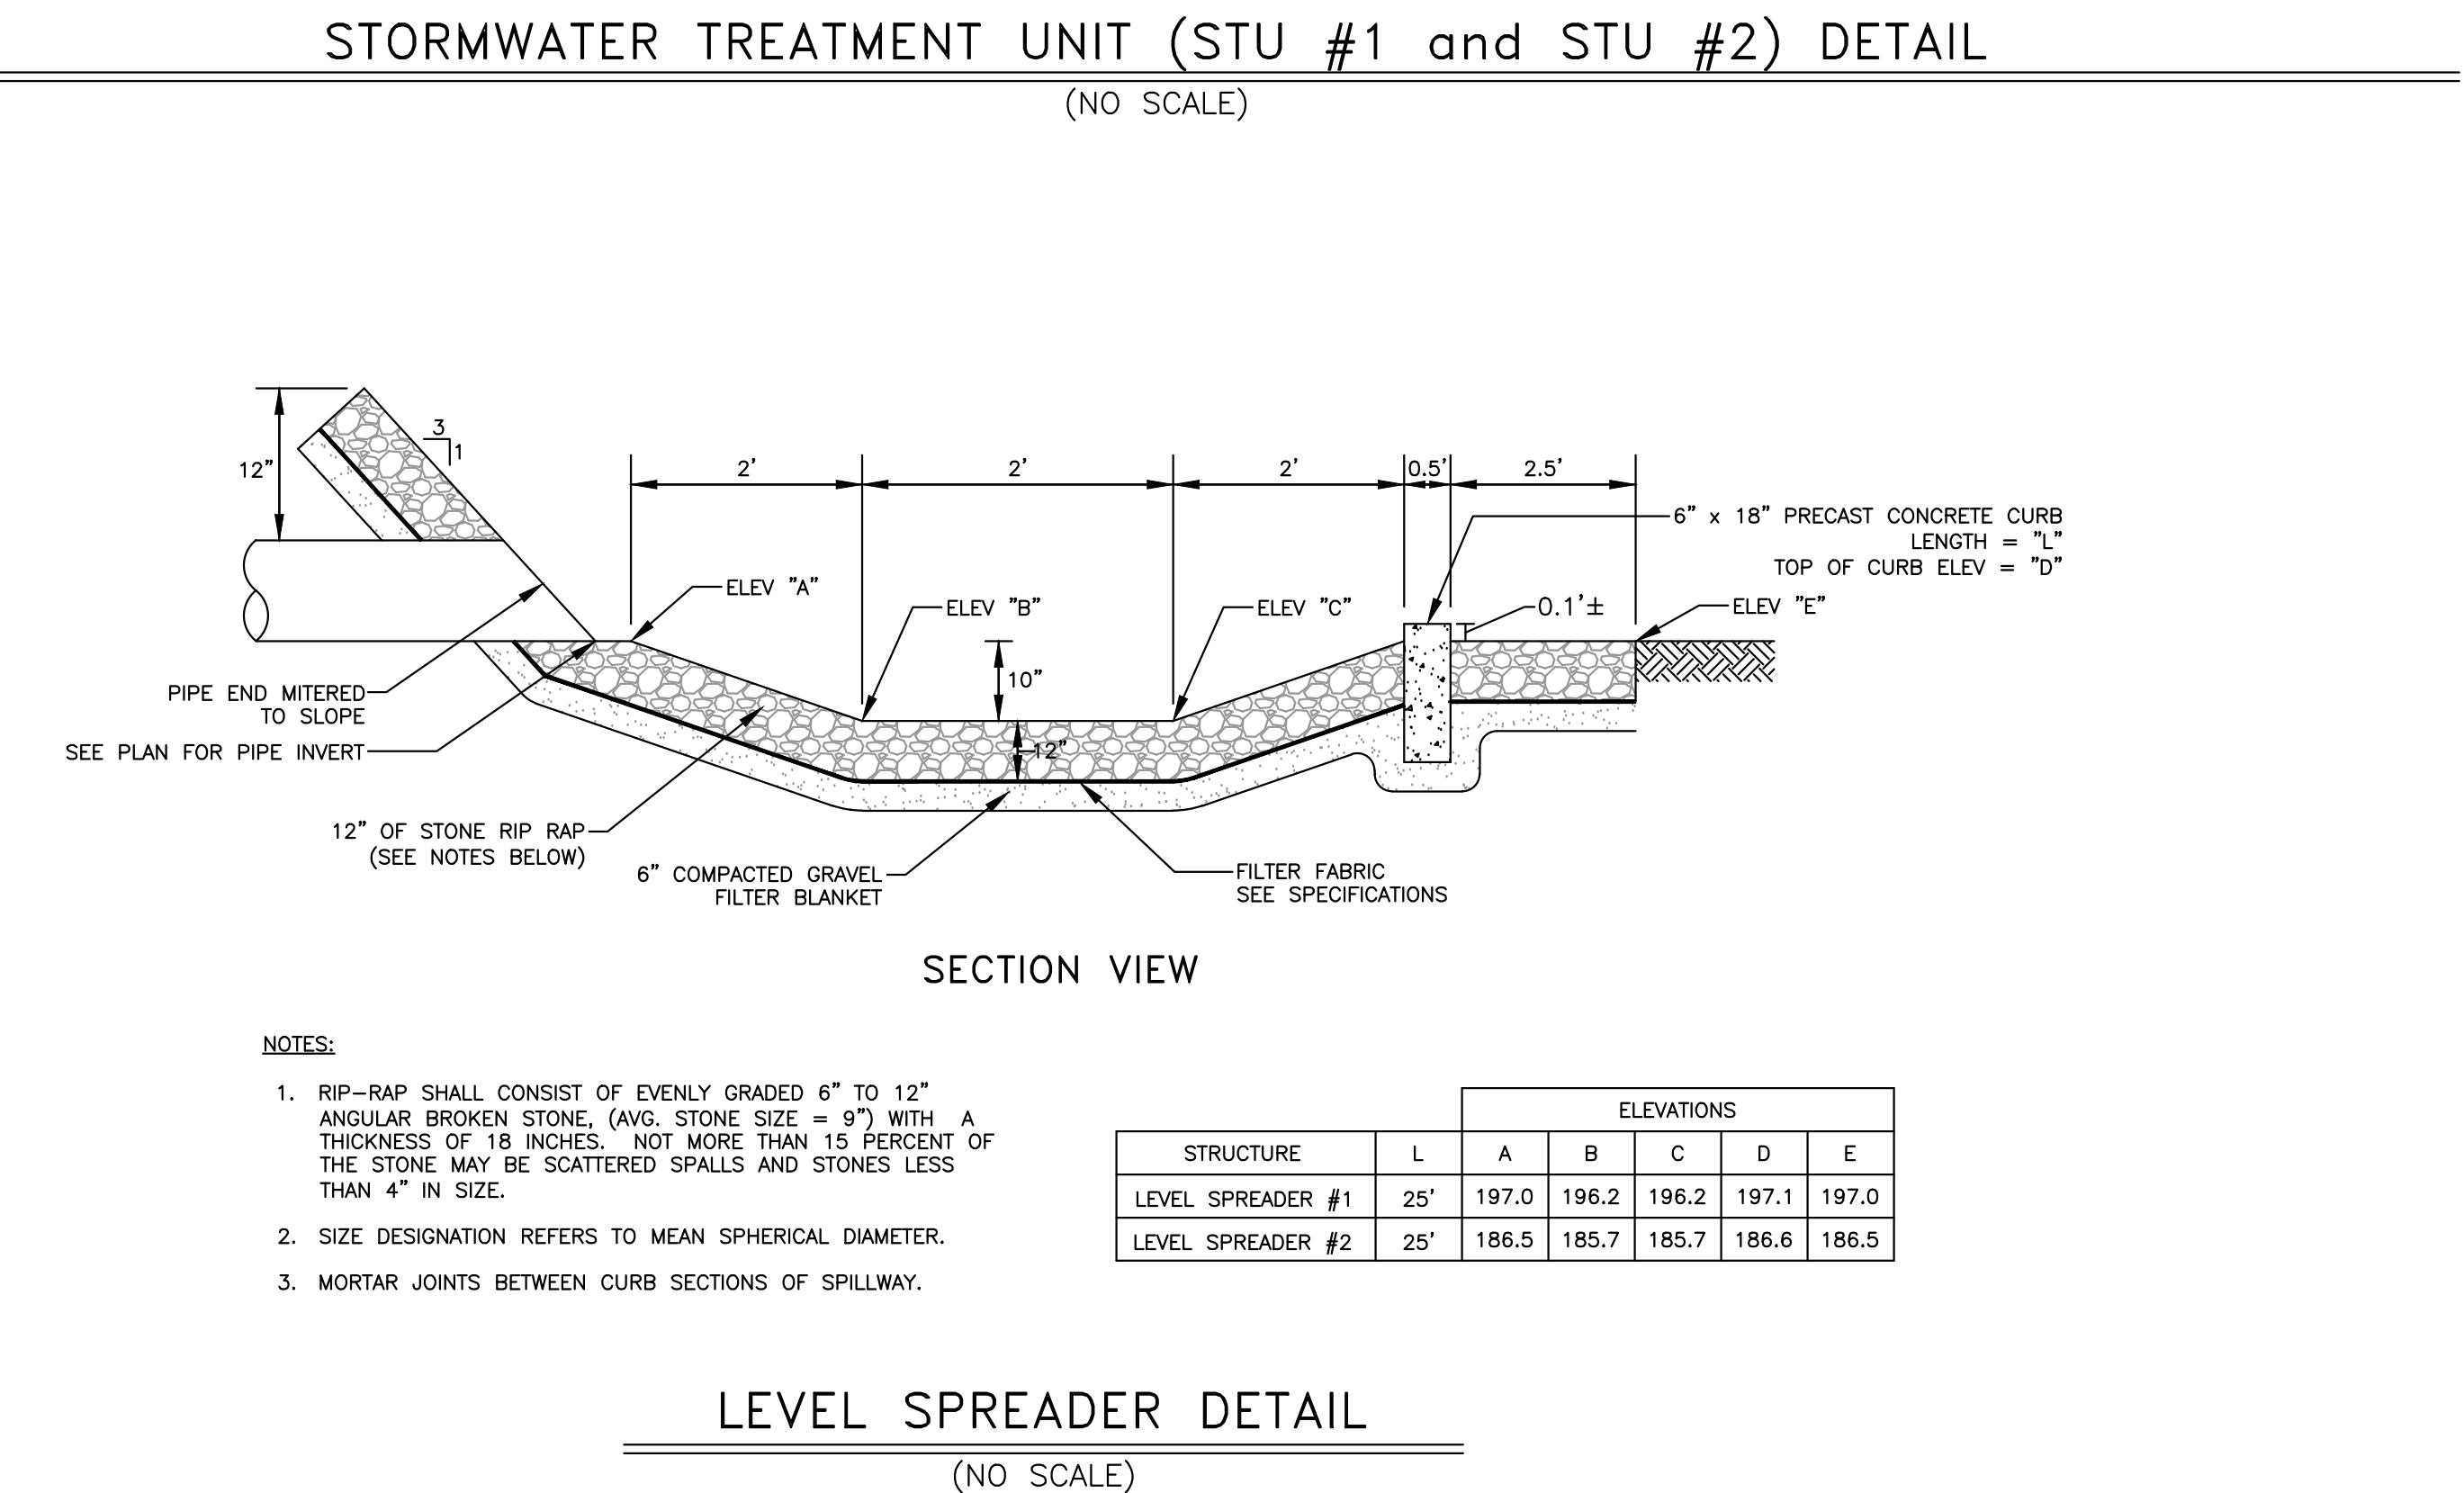


TYPICAL SEWER MANHOLE DETAIL
 (NO SCALE)

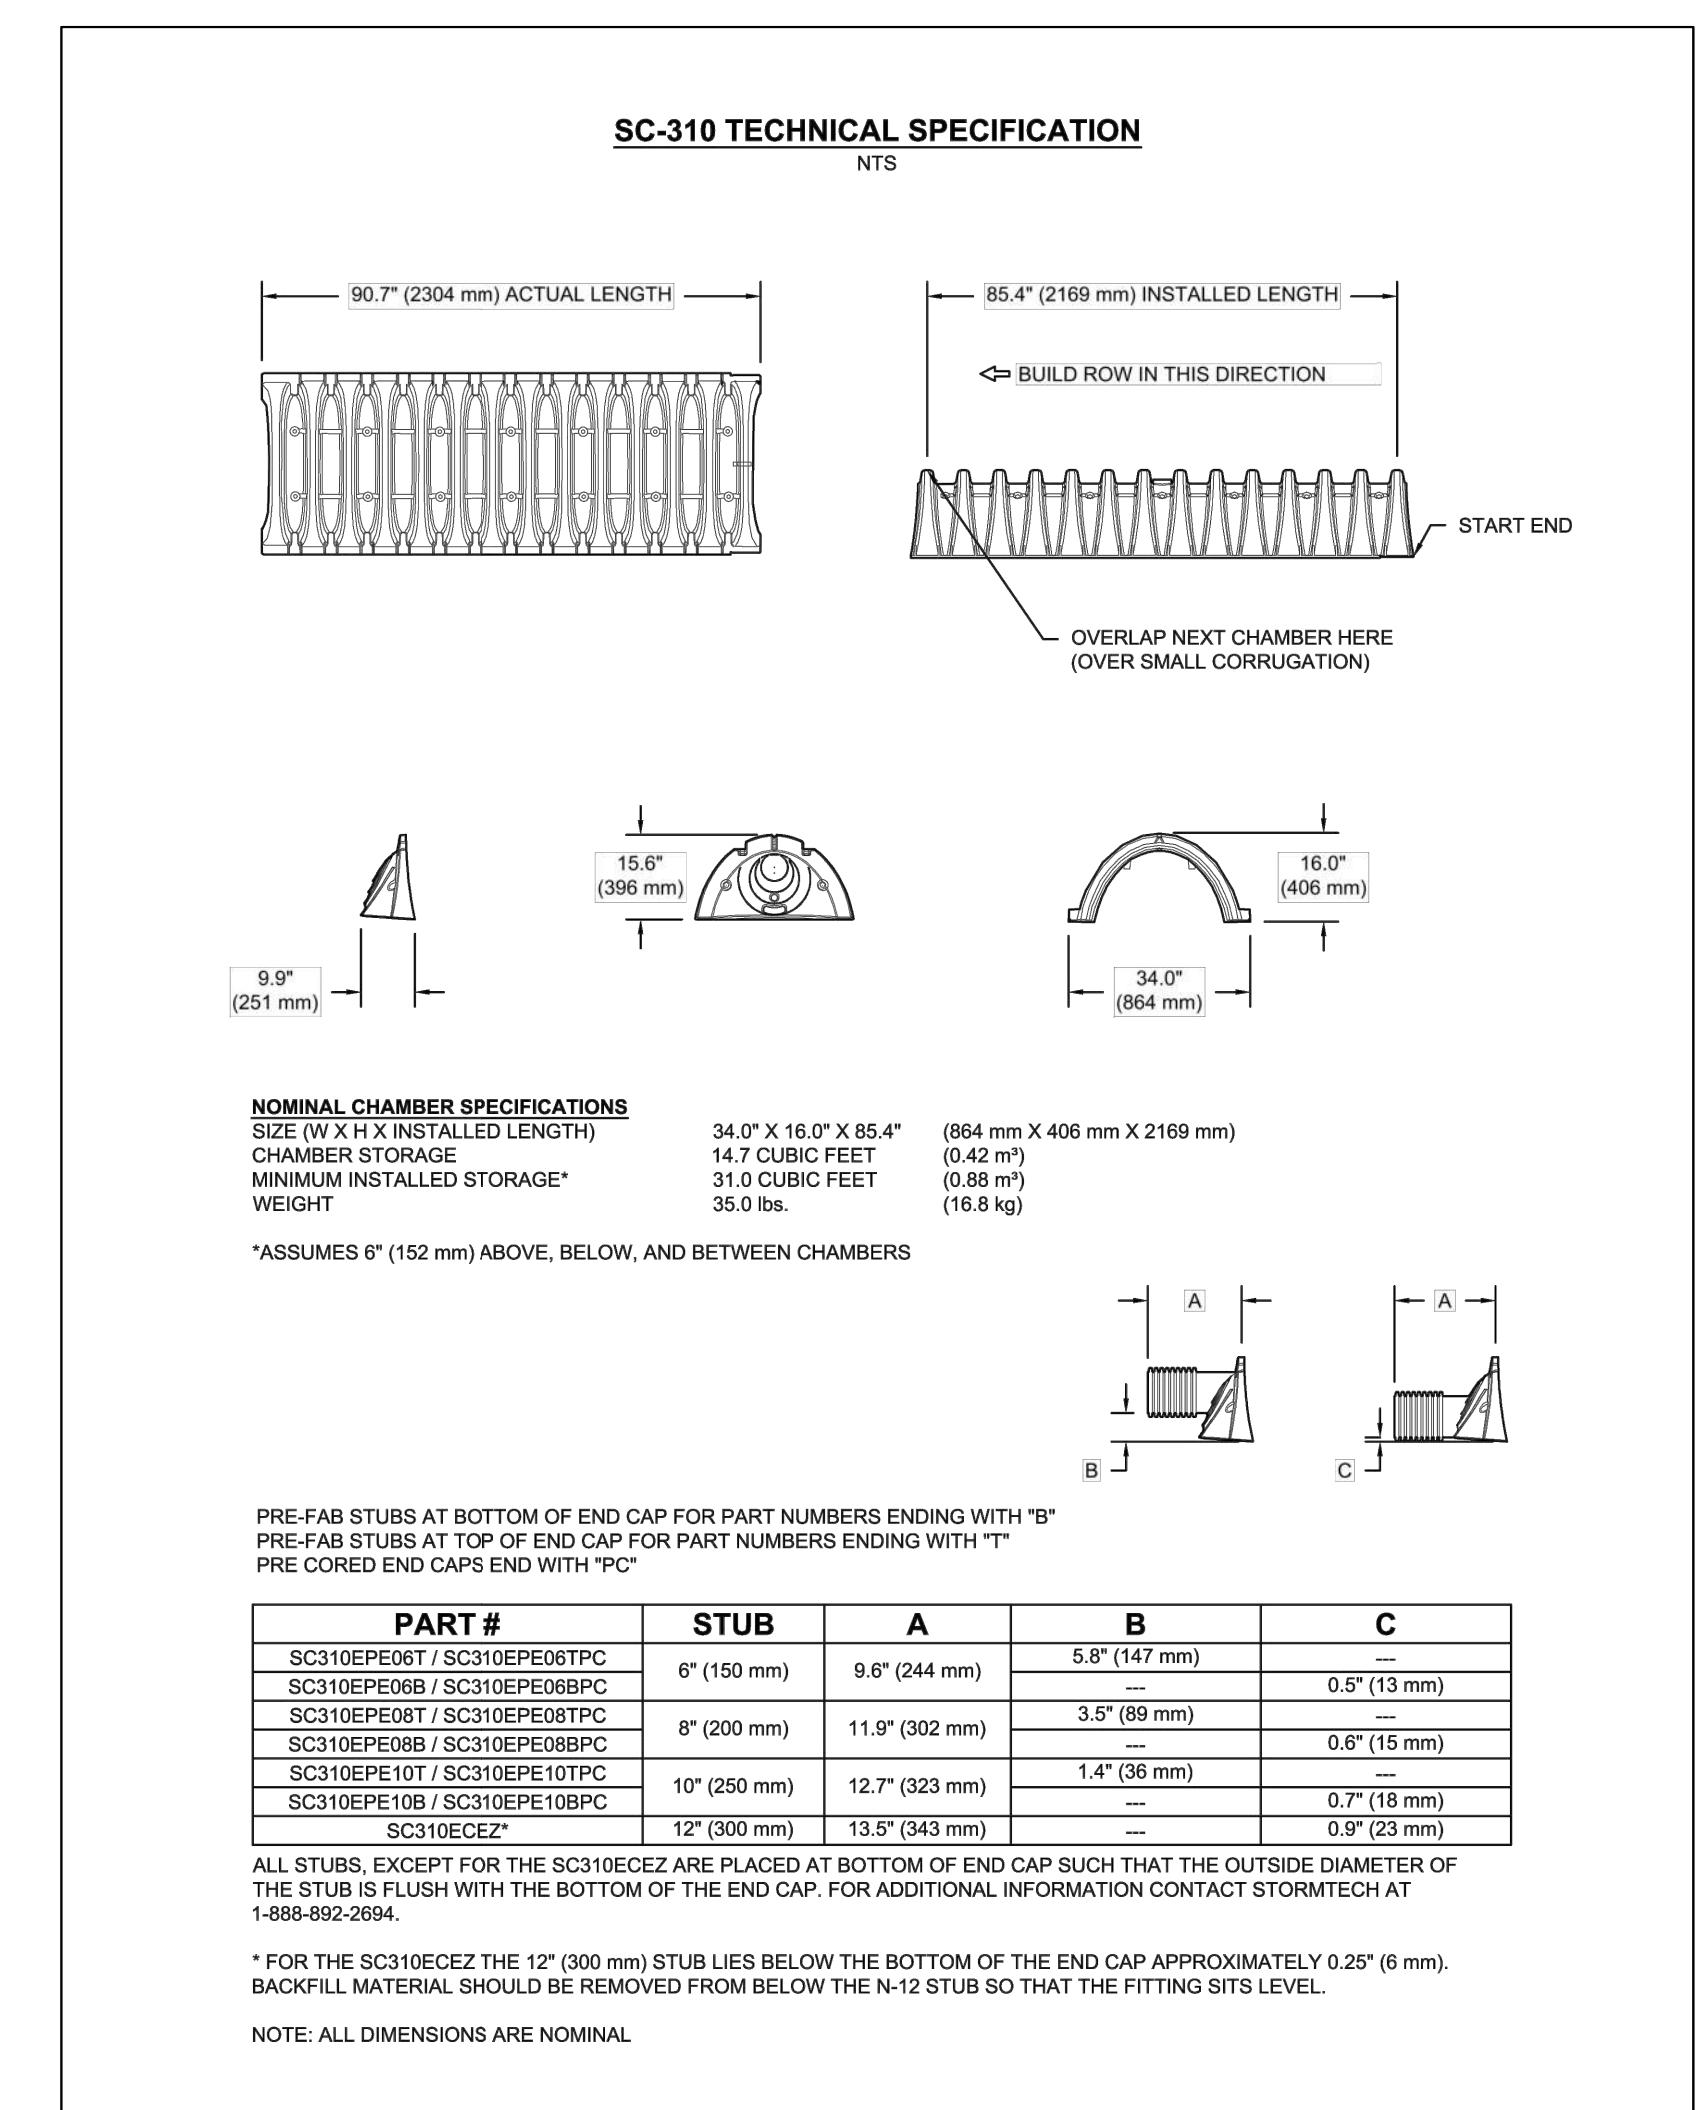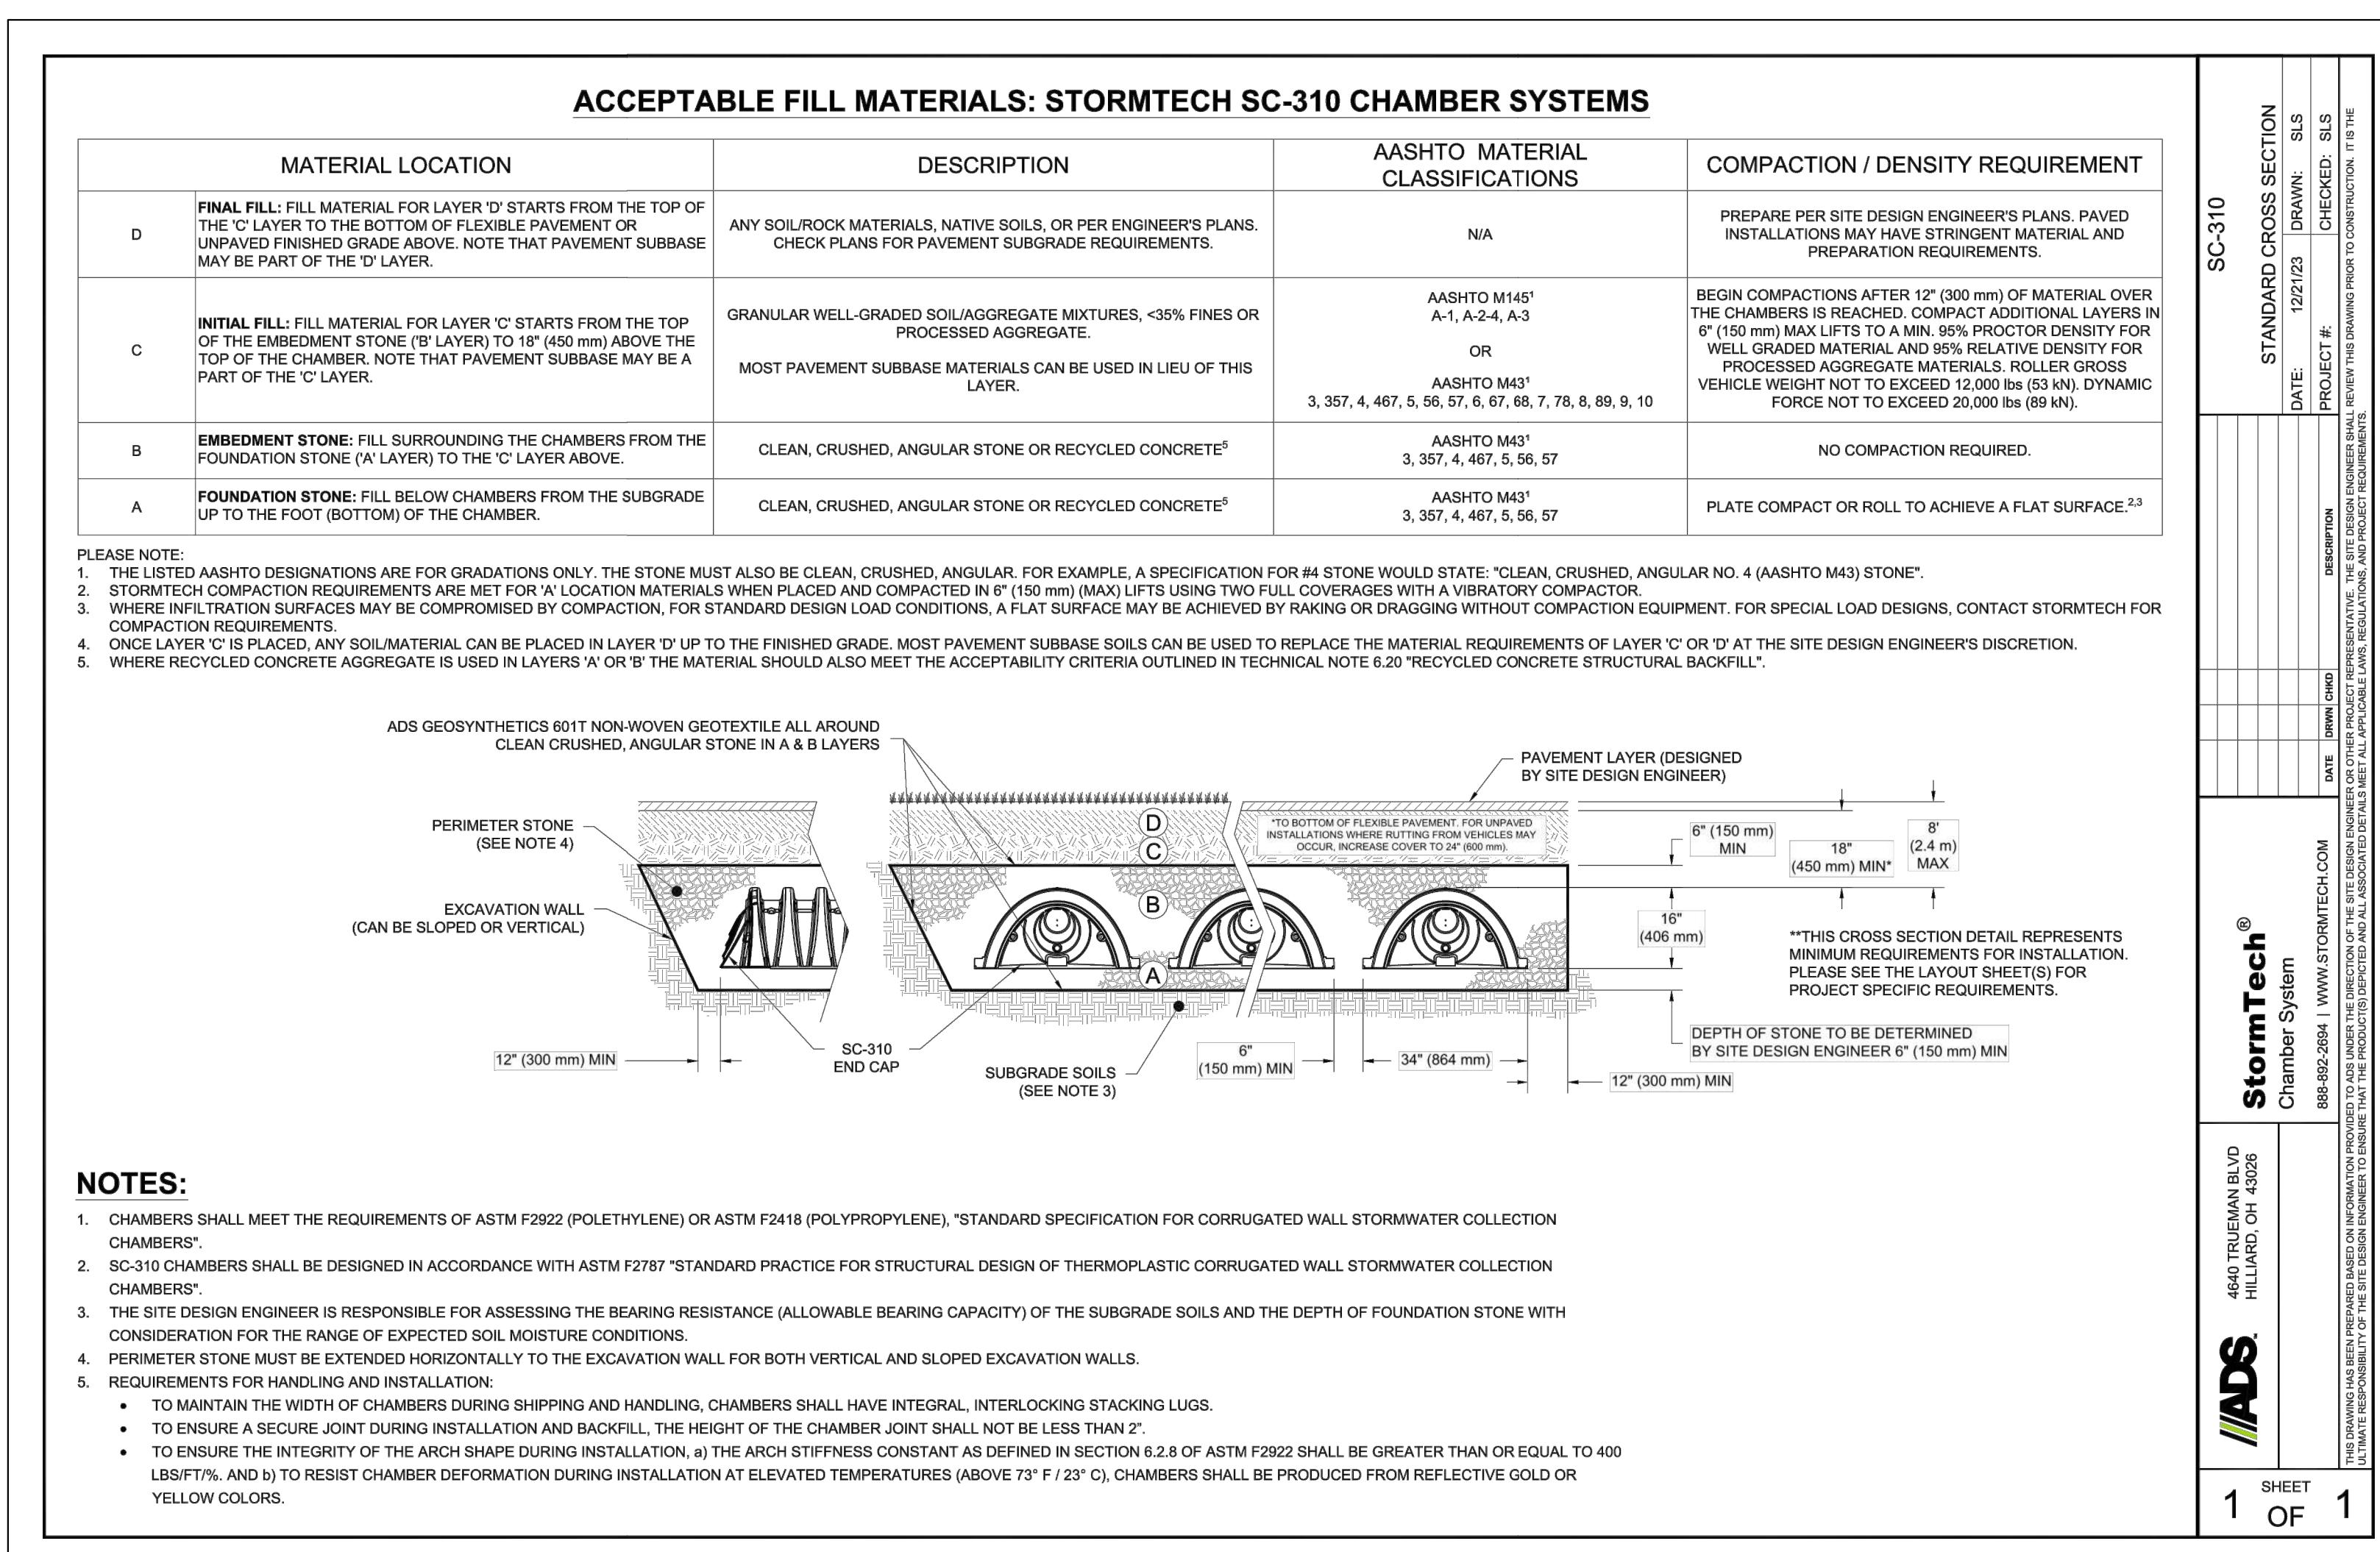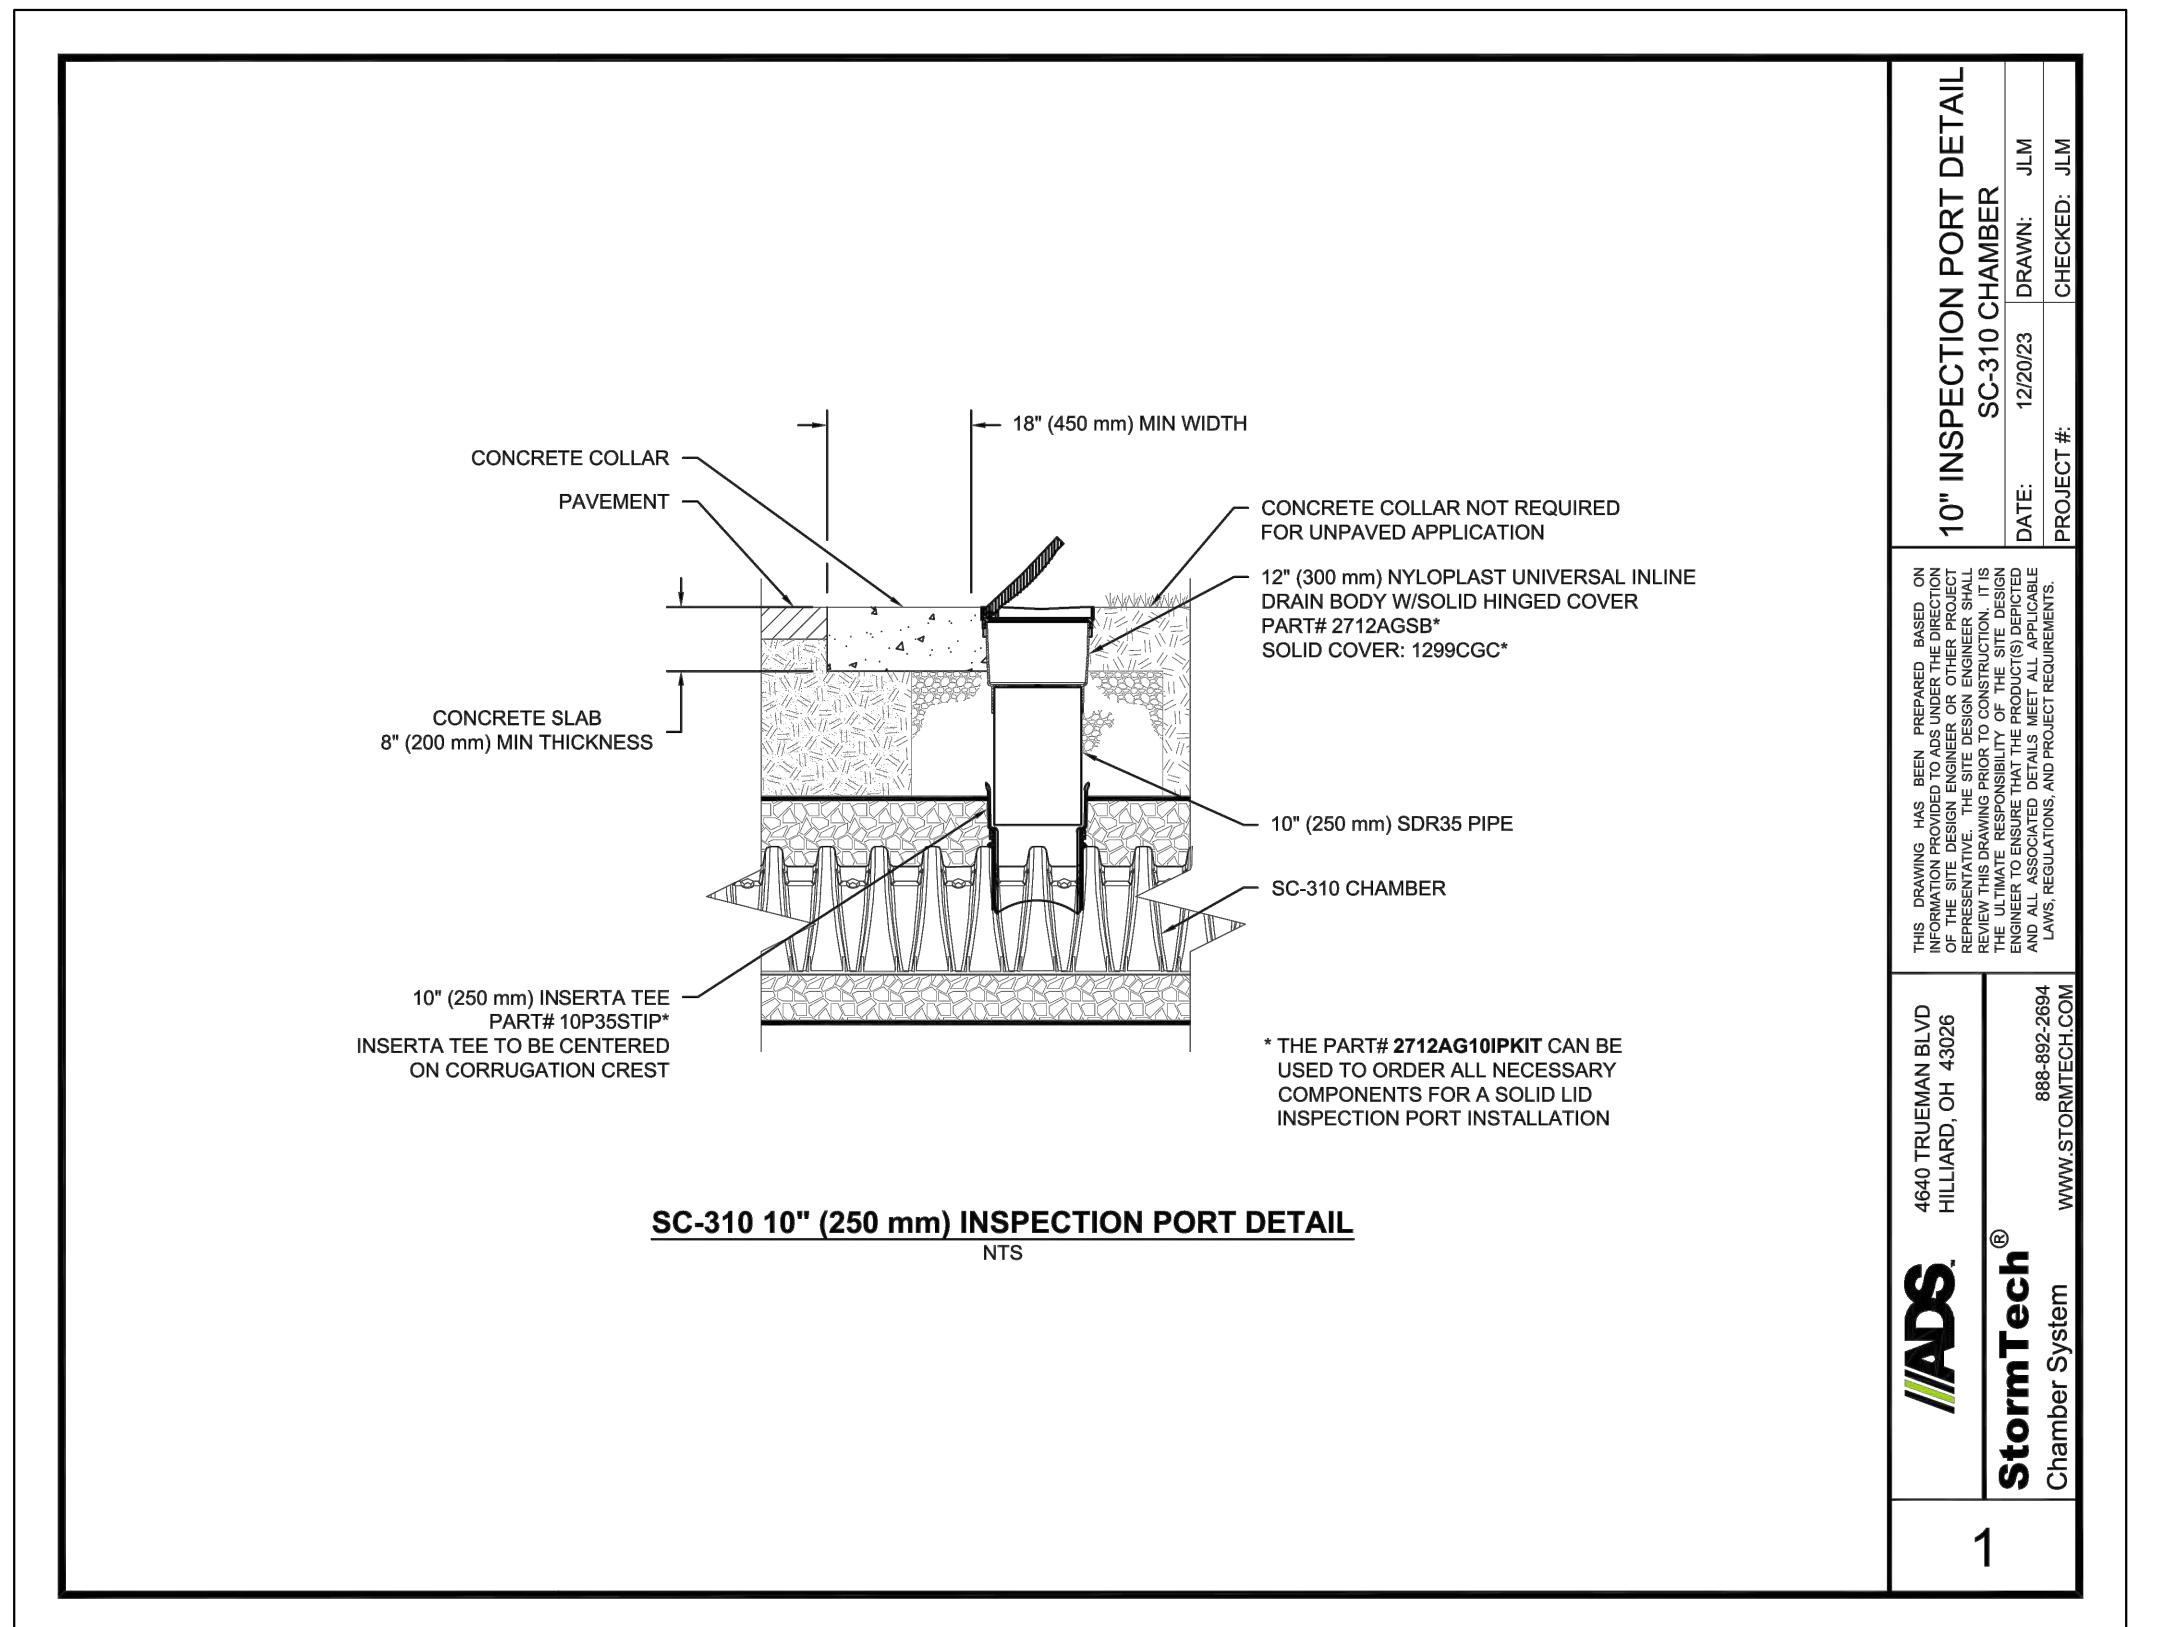

RECHARGER #1, #2 and #3 DETAILS

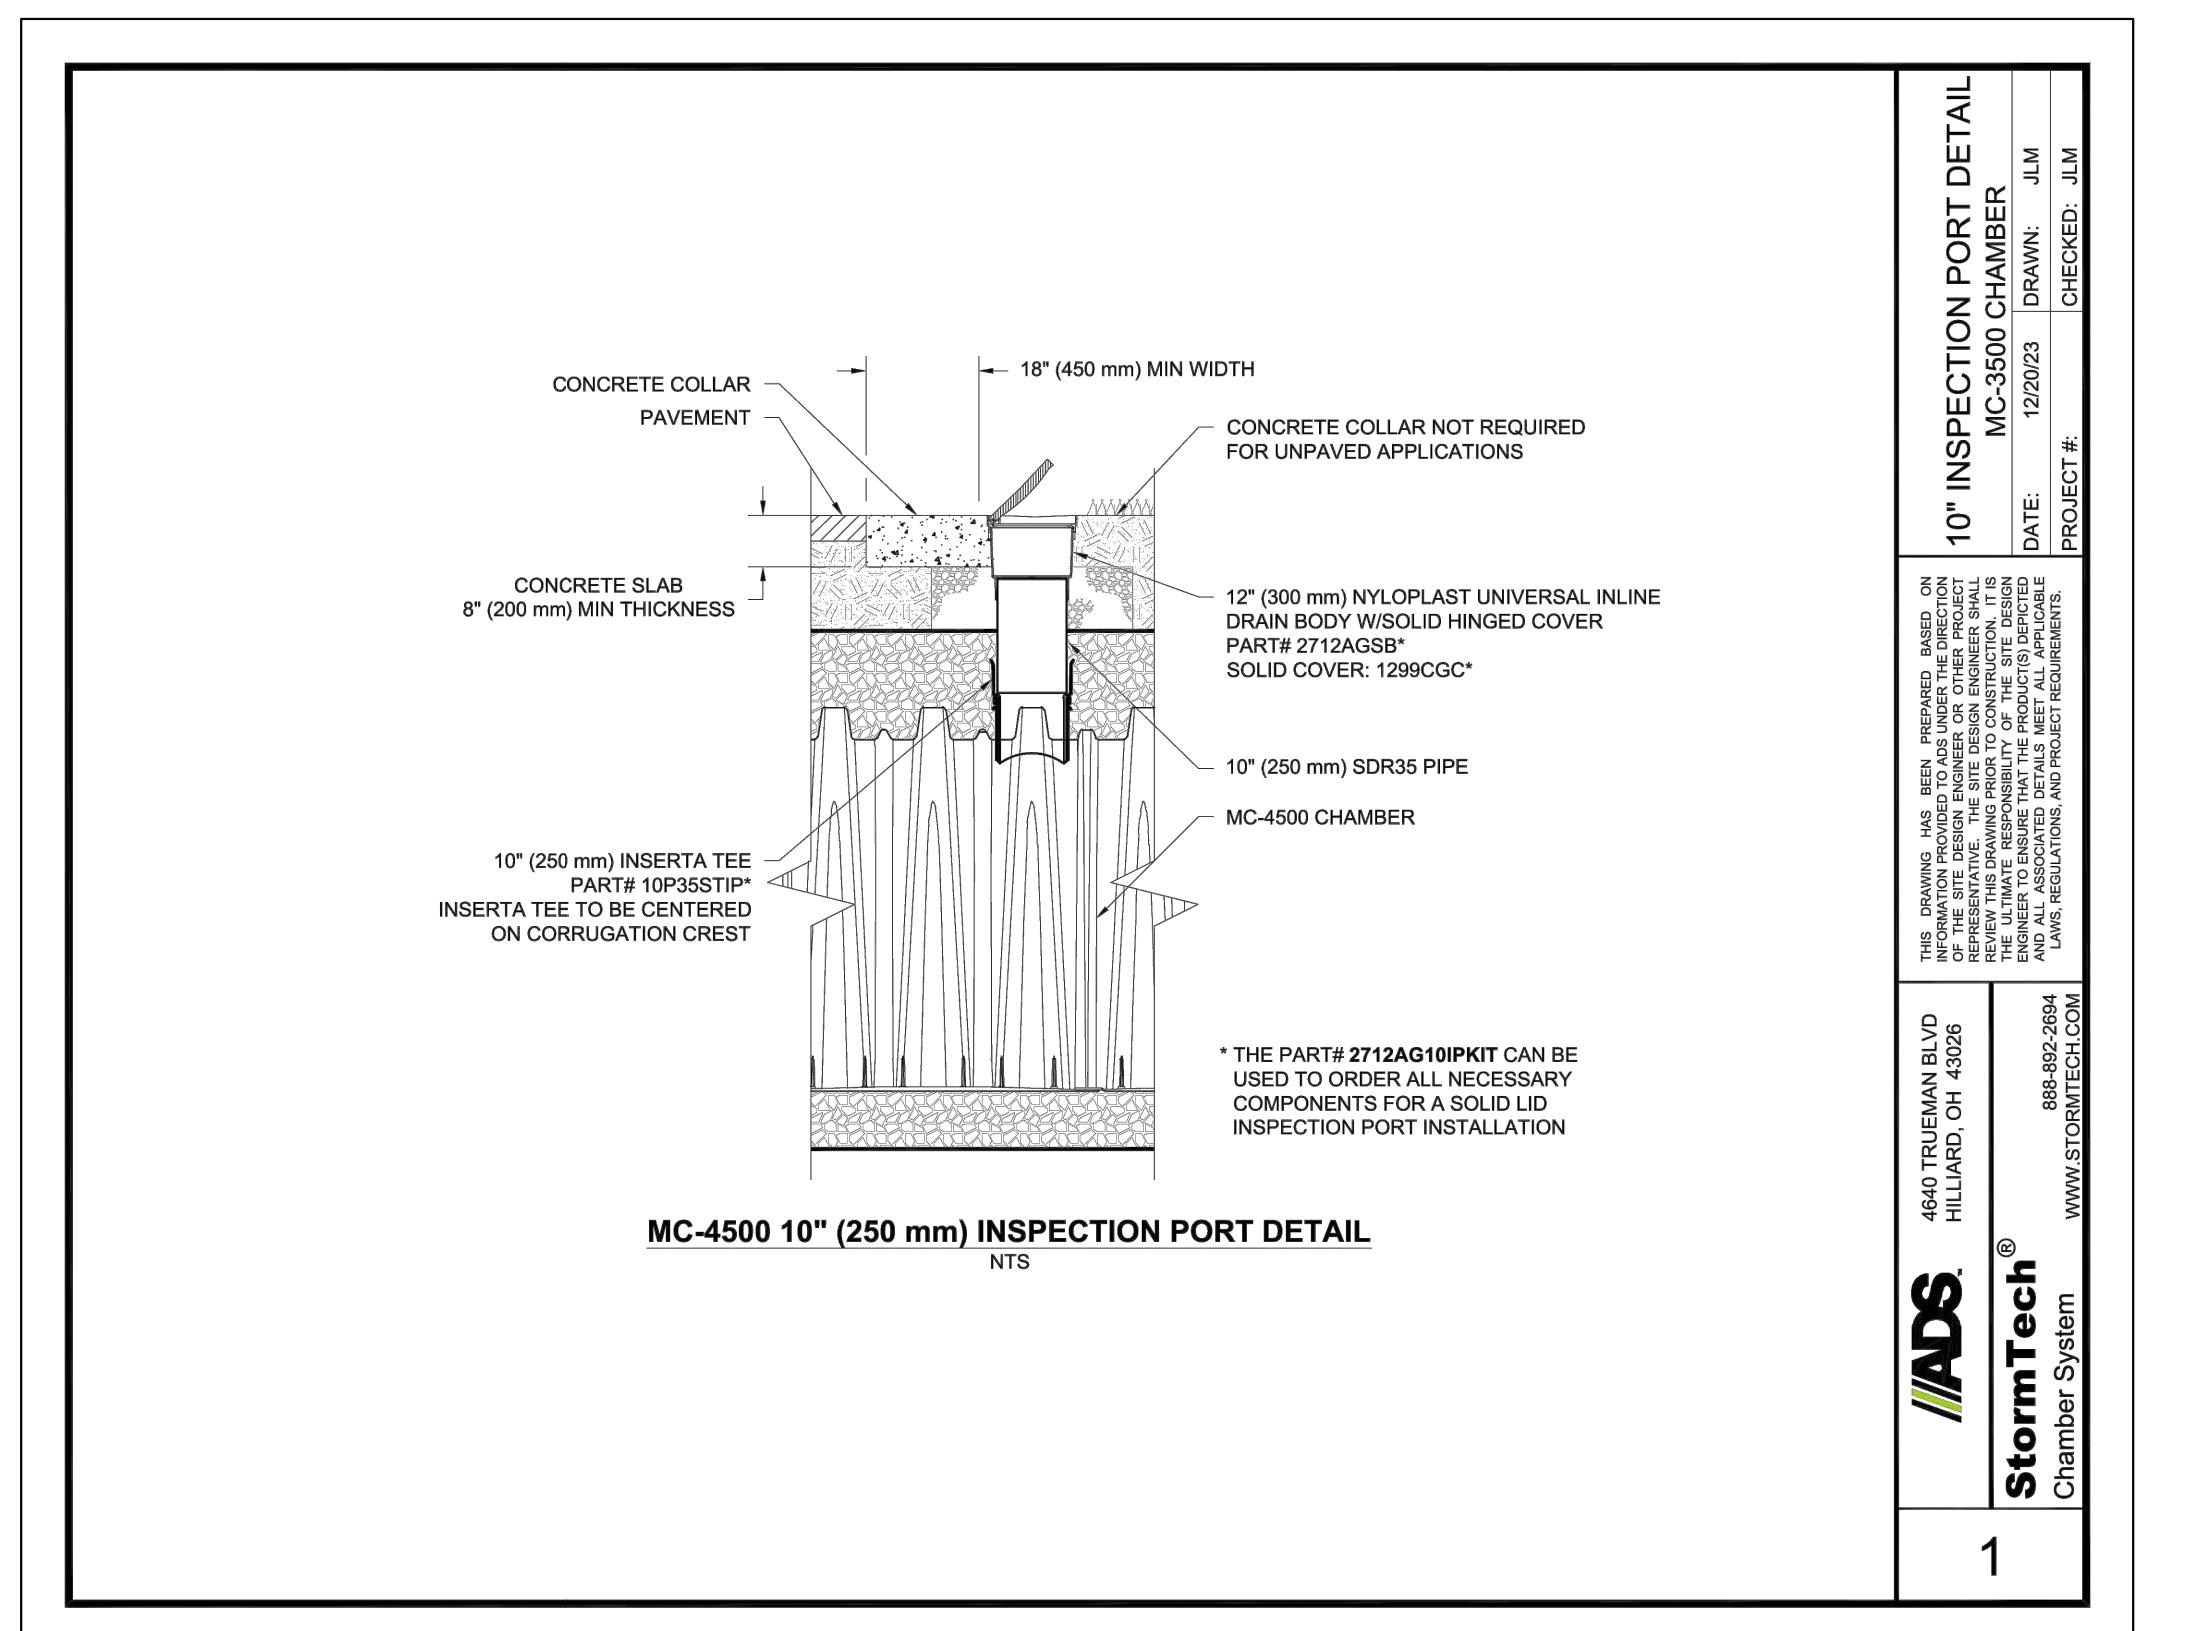

THE DESIGN OF DETENTION SYSTEM #2 IS BASED ON THE USE OF MC-3500 CHAMBERS BY ADVANCED DRAINAGE SYSTEMS (ADS) AS SHOWN IN THESE DETAILS. IF OTHER UNITS/CHAMBERS AND/OR CONFIGURATION IS TO BE PROPOSED BY THE CONTRACTOR, THEN SAID CONTRACTOR SHALL PROVIDE SHOP DRAWINGS OF THE CHAMBER UNITS PROPOSED, THE CONFIGURATION AND SYSTEM LAYOUT AND CALCULATIONS SHOWING CONFORMANCE WITH THE STORAGE REQUIREMENTS SHOWN BELOW. THE SHOP DRAWINGS AND CALCULATIONS SHALL BE SUBMITTED TO THE DESIGN ENGINEER FOR REVIEW AND APPROVAL.


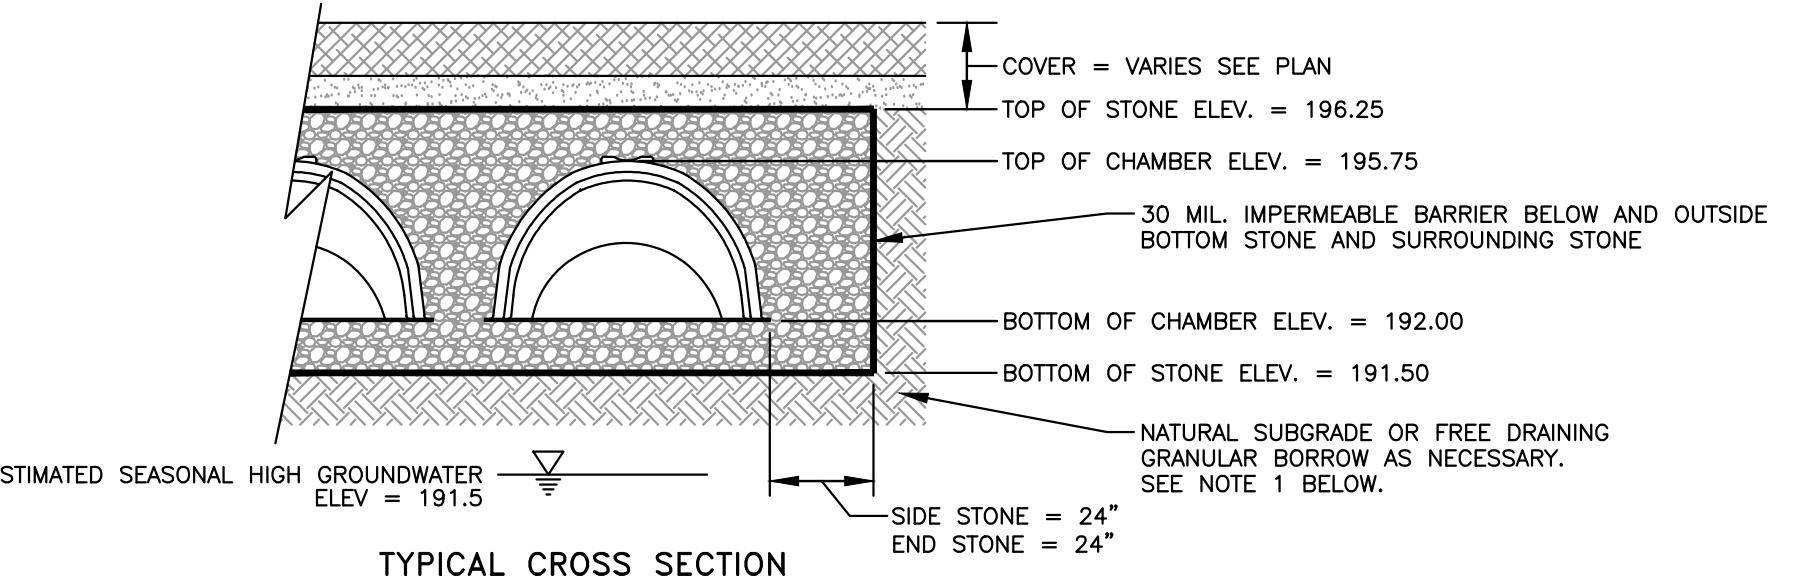


DETENTION SYSTEM #2 = 4 ROWS OF 15 CHAMBERS (60 TOTAL)
SEE PLAN FOR LAYOUT

GENERAL NOTES:

1. ALL TOPSOIL, SUBSOIL AND DELETERIOUS MATERIAL, IF ANY, MUST BE EXCAVATED AND REMOVED TO THE HORIZONTAL AND VERTICAL (BOTTOM OF STONE ELEVATION) LIMITS OF THE DETENTION FACILITY.
2. ALL WASHED STONE MUST HAVE LESS THAN 0.2 PERCENT MATERIAL FINER THAN A NUMBER 200 SIEVE AS DETERMINED BY THE A.A.S.H.T.O. TEST METHODS T-11 AND T-27 (LATEST EDITION).
3. CLEANOUT ACCESS COVERS TO BE BROUGHT TO FINISH GRADE IN THE LOCATIONS SHOWN ON THE PLAN. INSTALLATION OF CLEANOUT ACCESS COVERS PER THE MANUFACTURER'S DETAILS.

DETAIL OF SITE SPECIFIC REQUIREMENTS

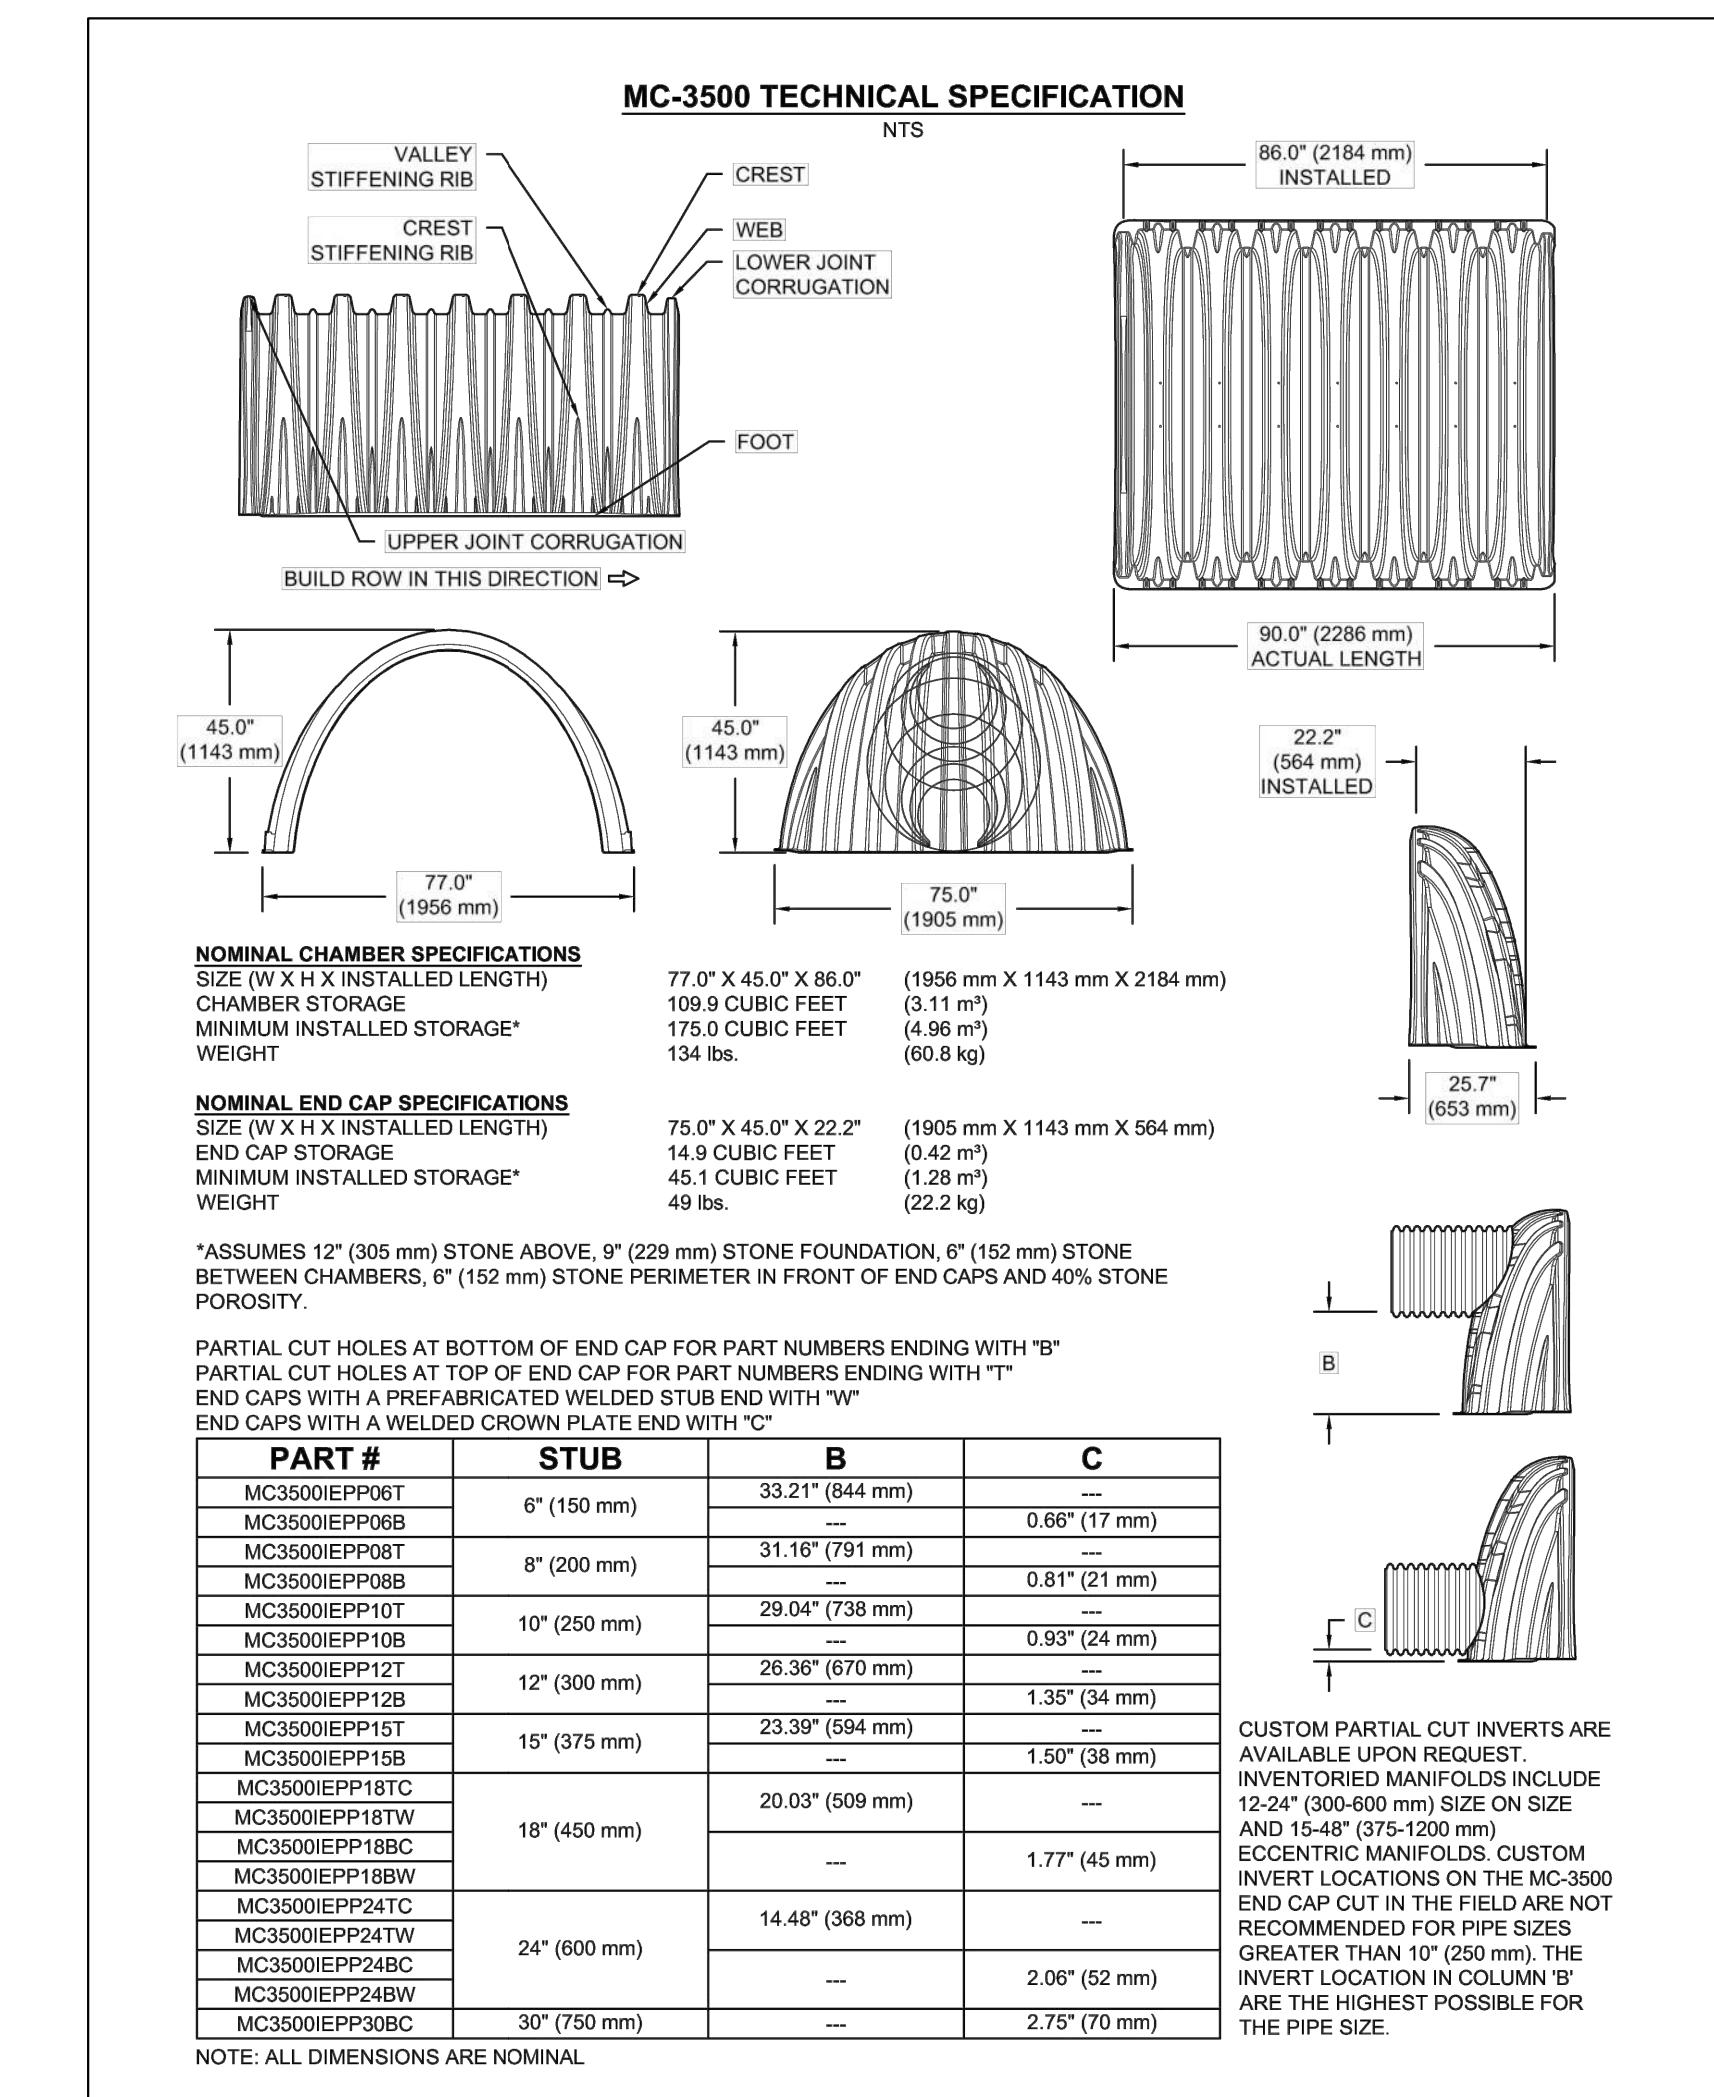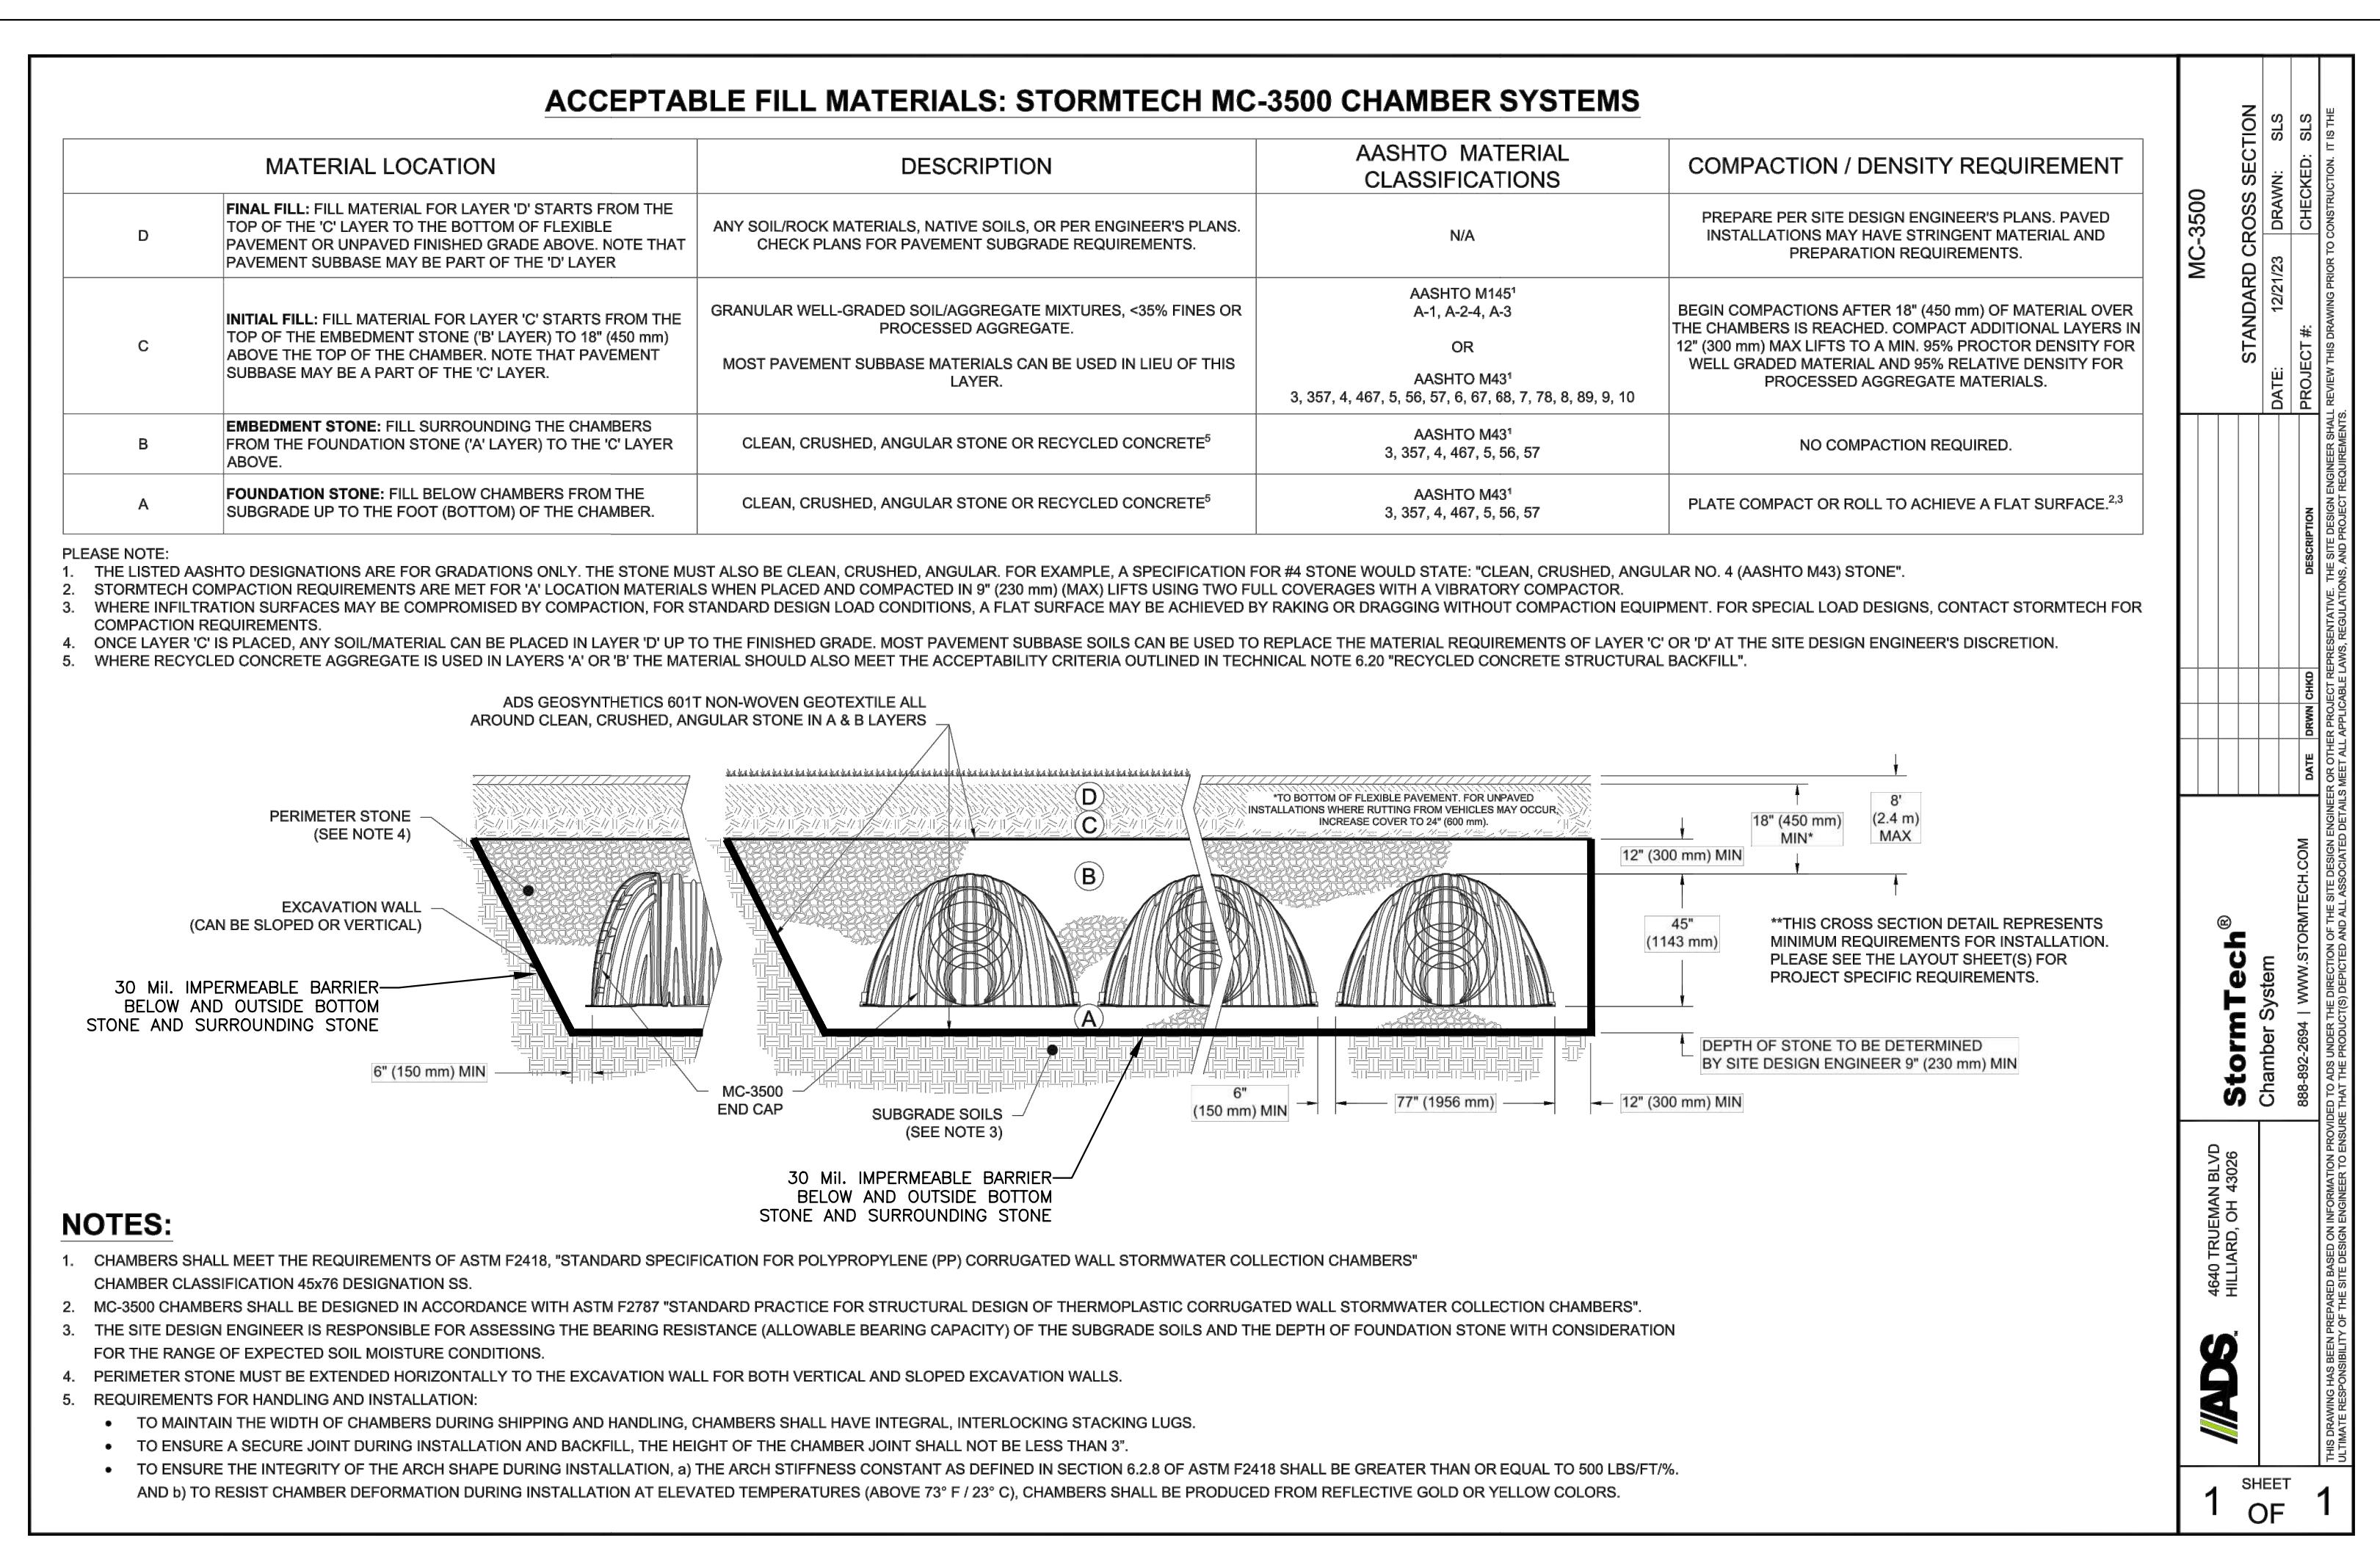

APPLICANT:
FENIX PARTNERS BRUSH HILL, LLC
177 LAKE STREET
SHERBORN, MA 01770

OWNER:
FENIX PARTNERS BRUSH HILL, LLC
ref.
MIDDLESEX REGISTRY OF DEEDS
BOOK: 81892 PAGE: 265

PARCEL ID:
MAP 1, LOT 0, BLOCK 18

ISSUED FOR:
COMPREHENSIVE PERMIT APPLICATION

BFRT E. COREY CIVIL No. 48423
REGISTERED PROFESSIONAL ENGINEER


2 BEC 9/19/24 PER BOH REVIEW COMMENTS
1 BEC 6/26/24 DESIGN DEVELOPMENT
NO. APP. DATE DESCRIPTION
DATE: JUNE 4, 2024
SCALE: AS NOTED
DESIGN: KMR/BEC DRAFTED: KMR CHECKED: BEC
PROJECT TITLE:

BRUSH HILL HOMES


34 BRUSH HILL ROAD SHERBORN, MA 01770

SHEET TITLE:

SITE DETAILS - 04
SHEET: 16 OF 17
PROJECT NO.: F-25889
C-16
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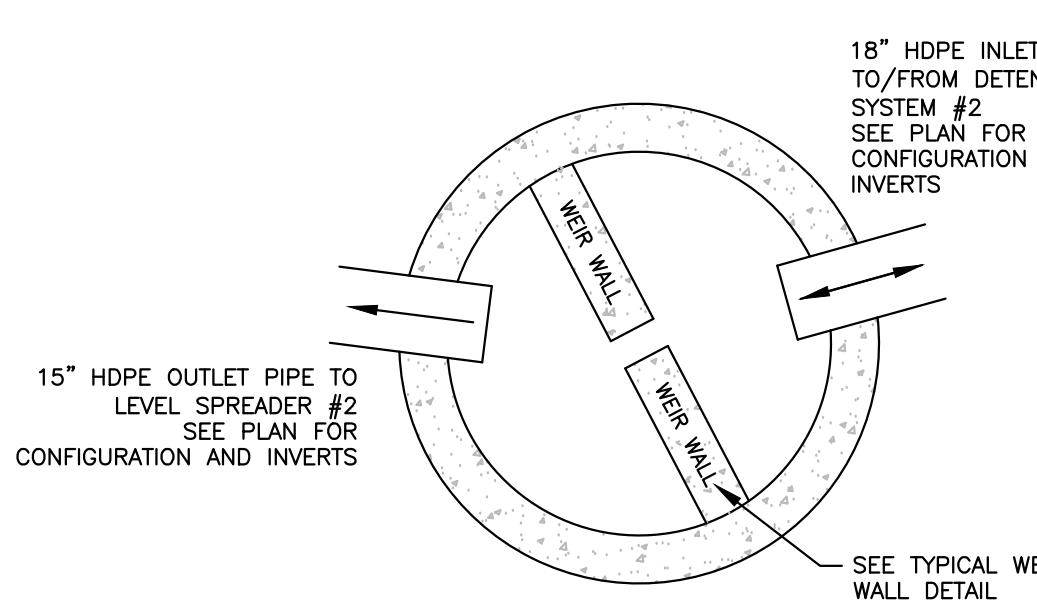


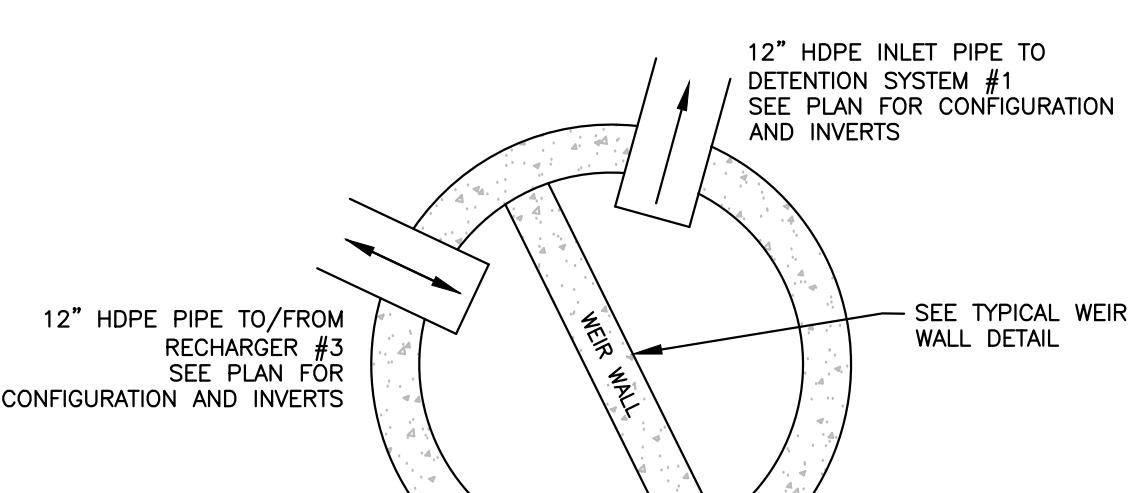OCS #4
TYPICAL PLAN VIEW

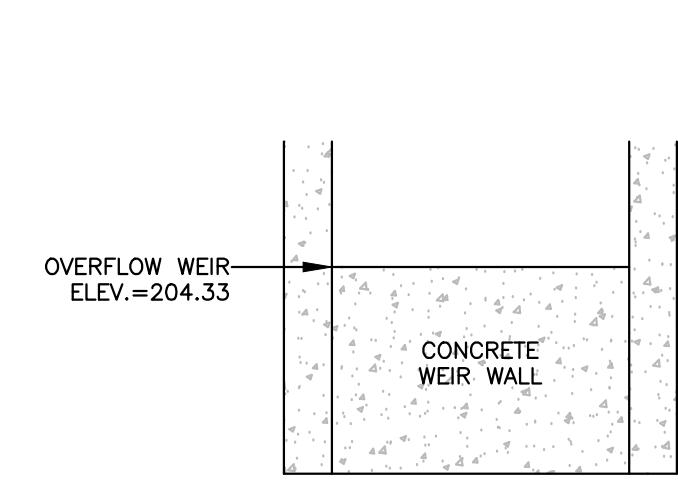


NOTES
1. WEIR WALL TO BE CAST IN PLACE BY THE MANUFACTURER.
2. WEIR WALL TO BE SEALED TO THE SIDE WALLS OF THE STRUCTURE TO CREATE TWO SEPARATE AND WATER TIGHT SIDES OF THE STRUCTURE.

OCS #4
TYPICAL WEIR WALL DETAIL




OCS #3
TYPICAL PLAN VIEW

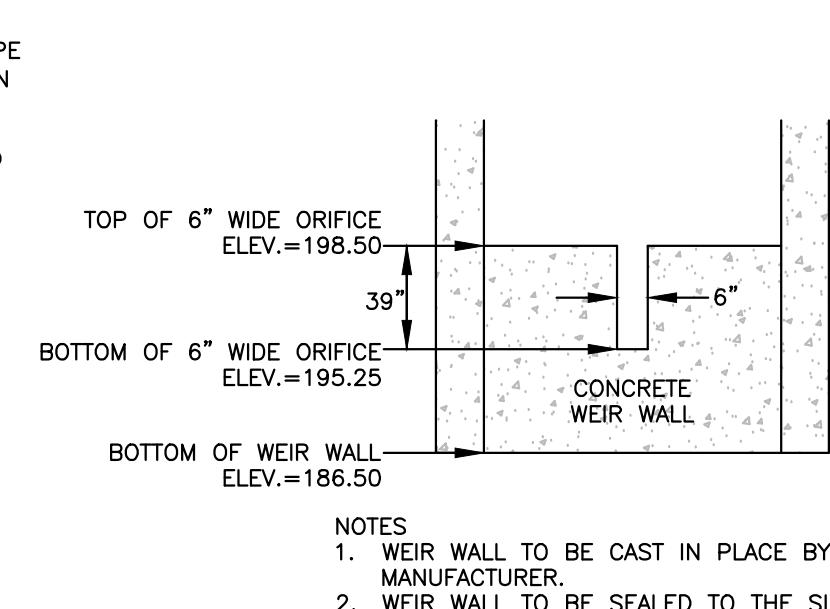


NOTES
1. WEIR WALL TO BE CAST IN PLACE BY THE MANUFACTURER.
2. WEIR WALL TO BE SEALED TO THE SIDE WALLS OF THE STRUCTURE TO CREATE TWO SEPARATE AND WATER TIGHT SIDES OF THE STRUCTURE.

OCS #3
TYPICAL WEIR WALL DETAIL

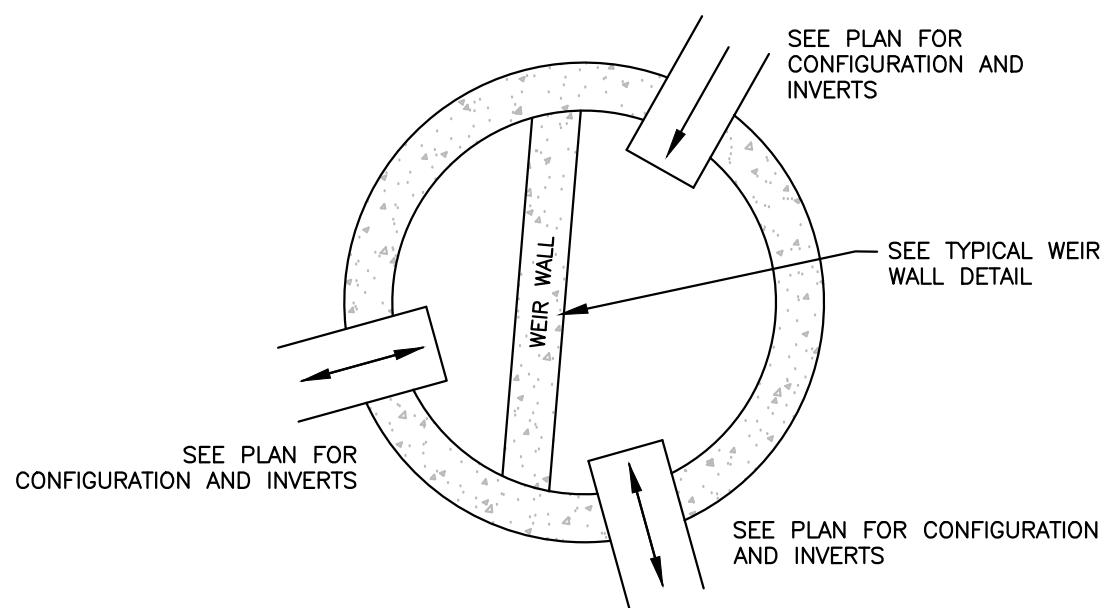


OCS #2
TYPICAL PLAN VIEW

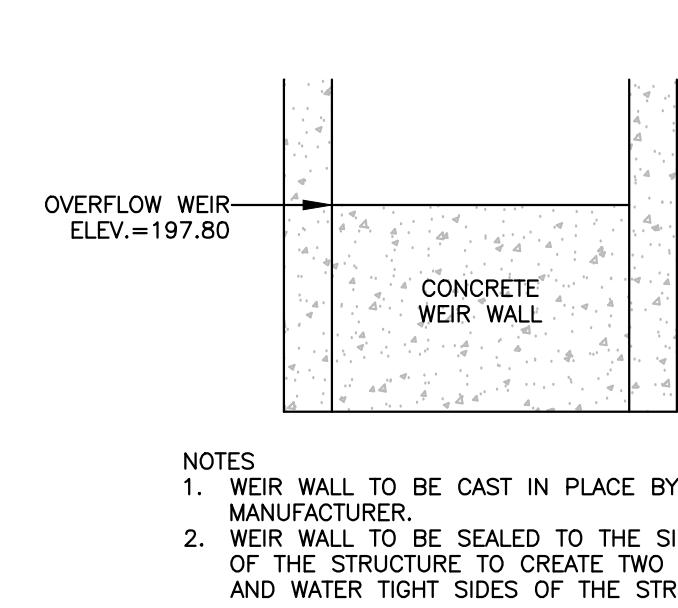


NOTES
1. WEIR WALL TO BE CAST IN PLACE BY THE MANUFACTURER.
2. WEIR WALL TO BE SEALED TO THE SIDE WALLS OF THE STRUCTURE TO CREATE TWO SEPARATE AND WATER TIGHT SIDES OF THE STRUCTURE.

OCS #2
TYPICAL WEIR WALL DETAIL

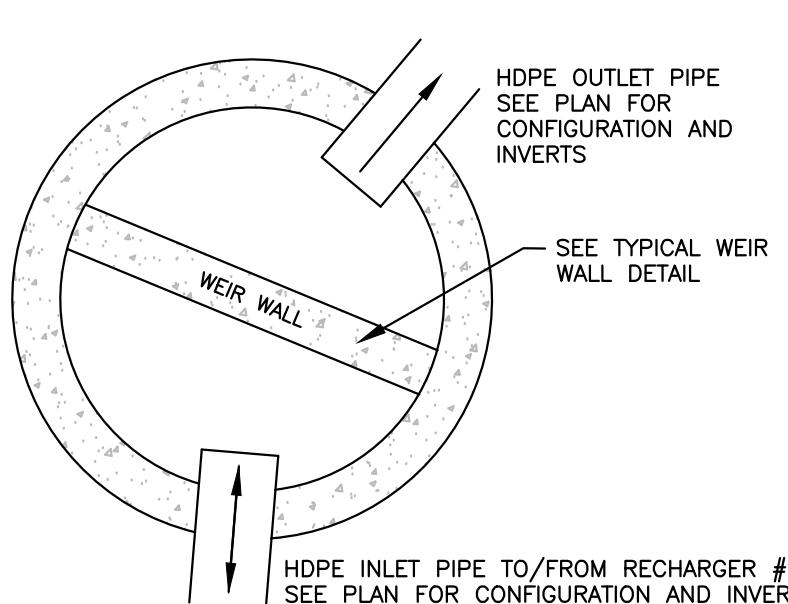


OCS #1 & #6
TYPICAL PLAN VIEW

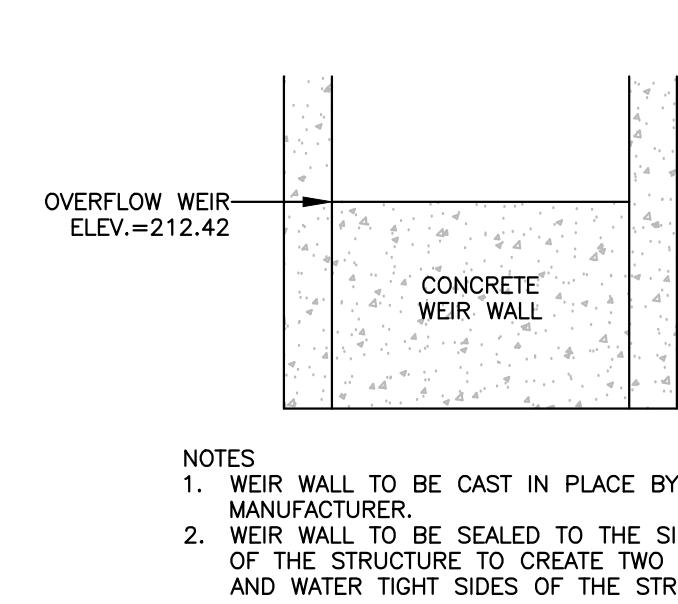

NOTES
1. WEIR WALL TO BE CAST IN PLACE BY THE MANUFACTURER.
2. WEIR WALL TO BE SEALED TO THE SIDE WALLS OF THE STRUCTURE TO CREATE TWO SEPARATE AND WATER TIGHT SIDES OF THE STRUCTURE.

OCS #1 & #6
TYPICAL WEIR WALL DETAIL

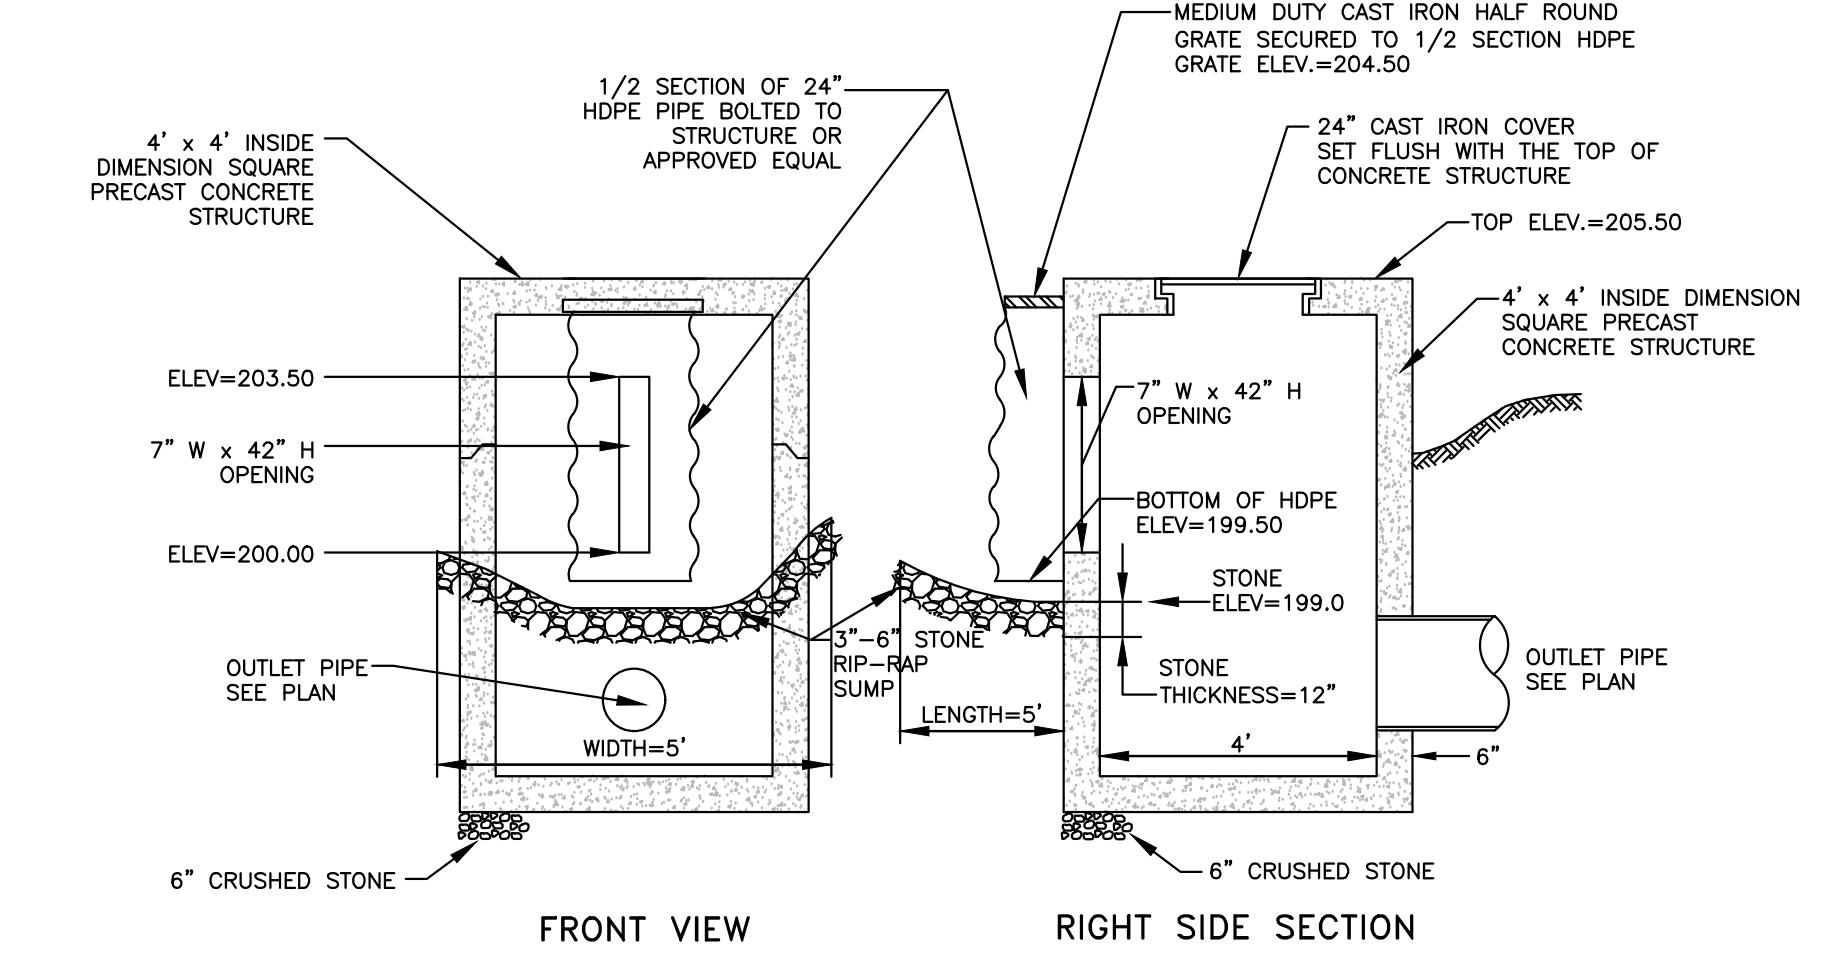

OUTLET CONTROL STRUCTURE DETAIL for OCS #5

(NO SCALE)


APPLICANT:
FENIX PARTNERS BRUSH HILL, LLC
177 LAKE STREET
SHERBORN, MA 01770

OWNER:
FENIX PARTNERS BRUSH HILL, LLC
ref.
MIDDLESEX REGISTRY OF DEEDS
BOOK: 81892 PAGE: 265

PARCEL ID:

MAP 1, LOT 0, BLOCK 18

ISSUED FOR:
**COMPREHENSIVE
PERMIT APPLICATION**

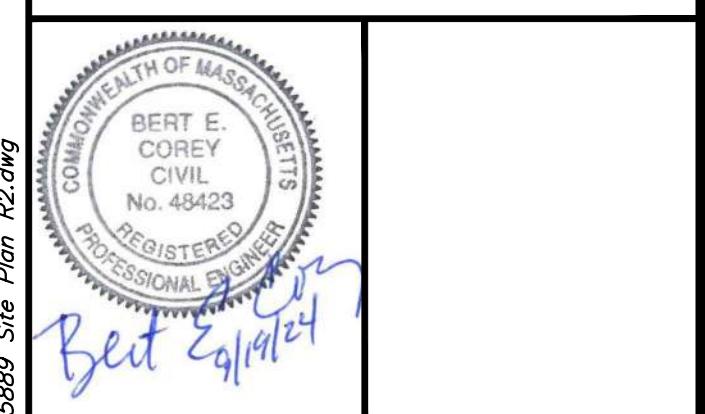

2	BEC	9/19/24	PER BOH REVIEW COMMENTS
1	BEC	6/26/24	DESIGN DEVELOPMENT

NO. APP DATE DESCRIPTION

DATE: JUNE 4, 2024

SCALE: AS NOTED

DESIGN: KMR/BEC DRAFTED: KMR CHECKED: BEC

PROJECT TITLE:

BRUSH HILL HOMES

34 BRUSH HILL ROAD
SHERBORN, MA 01770


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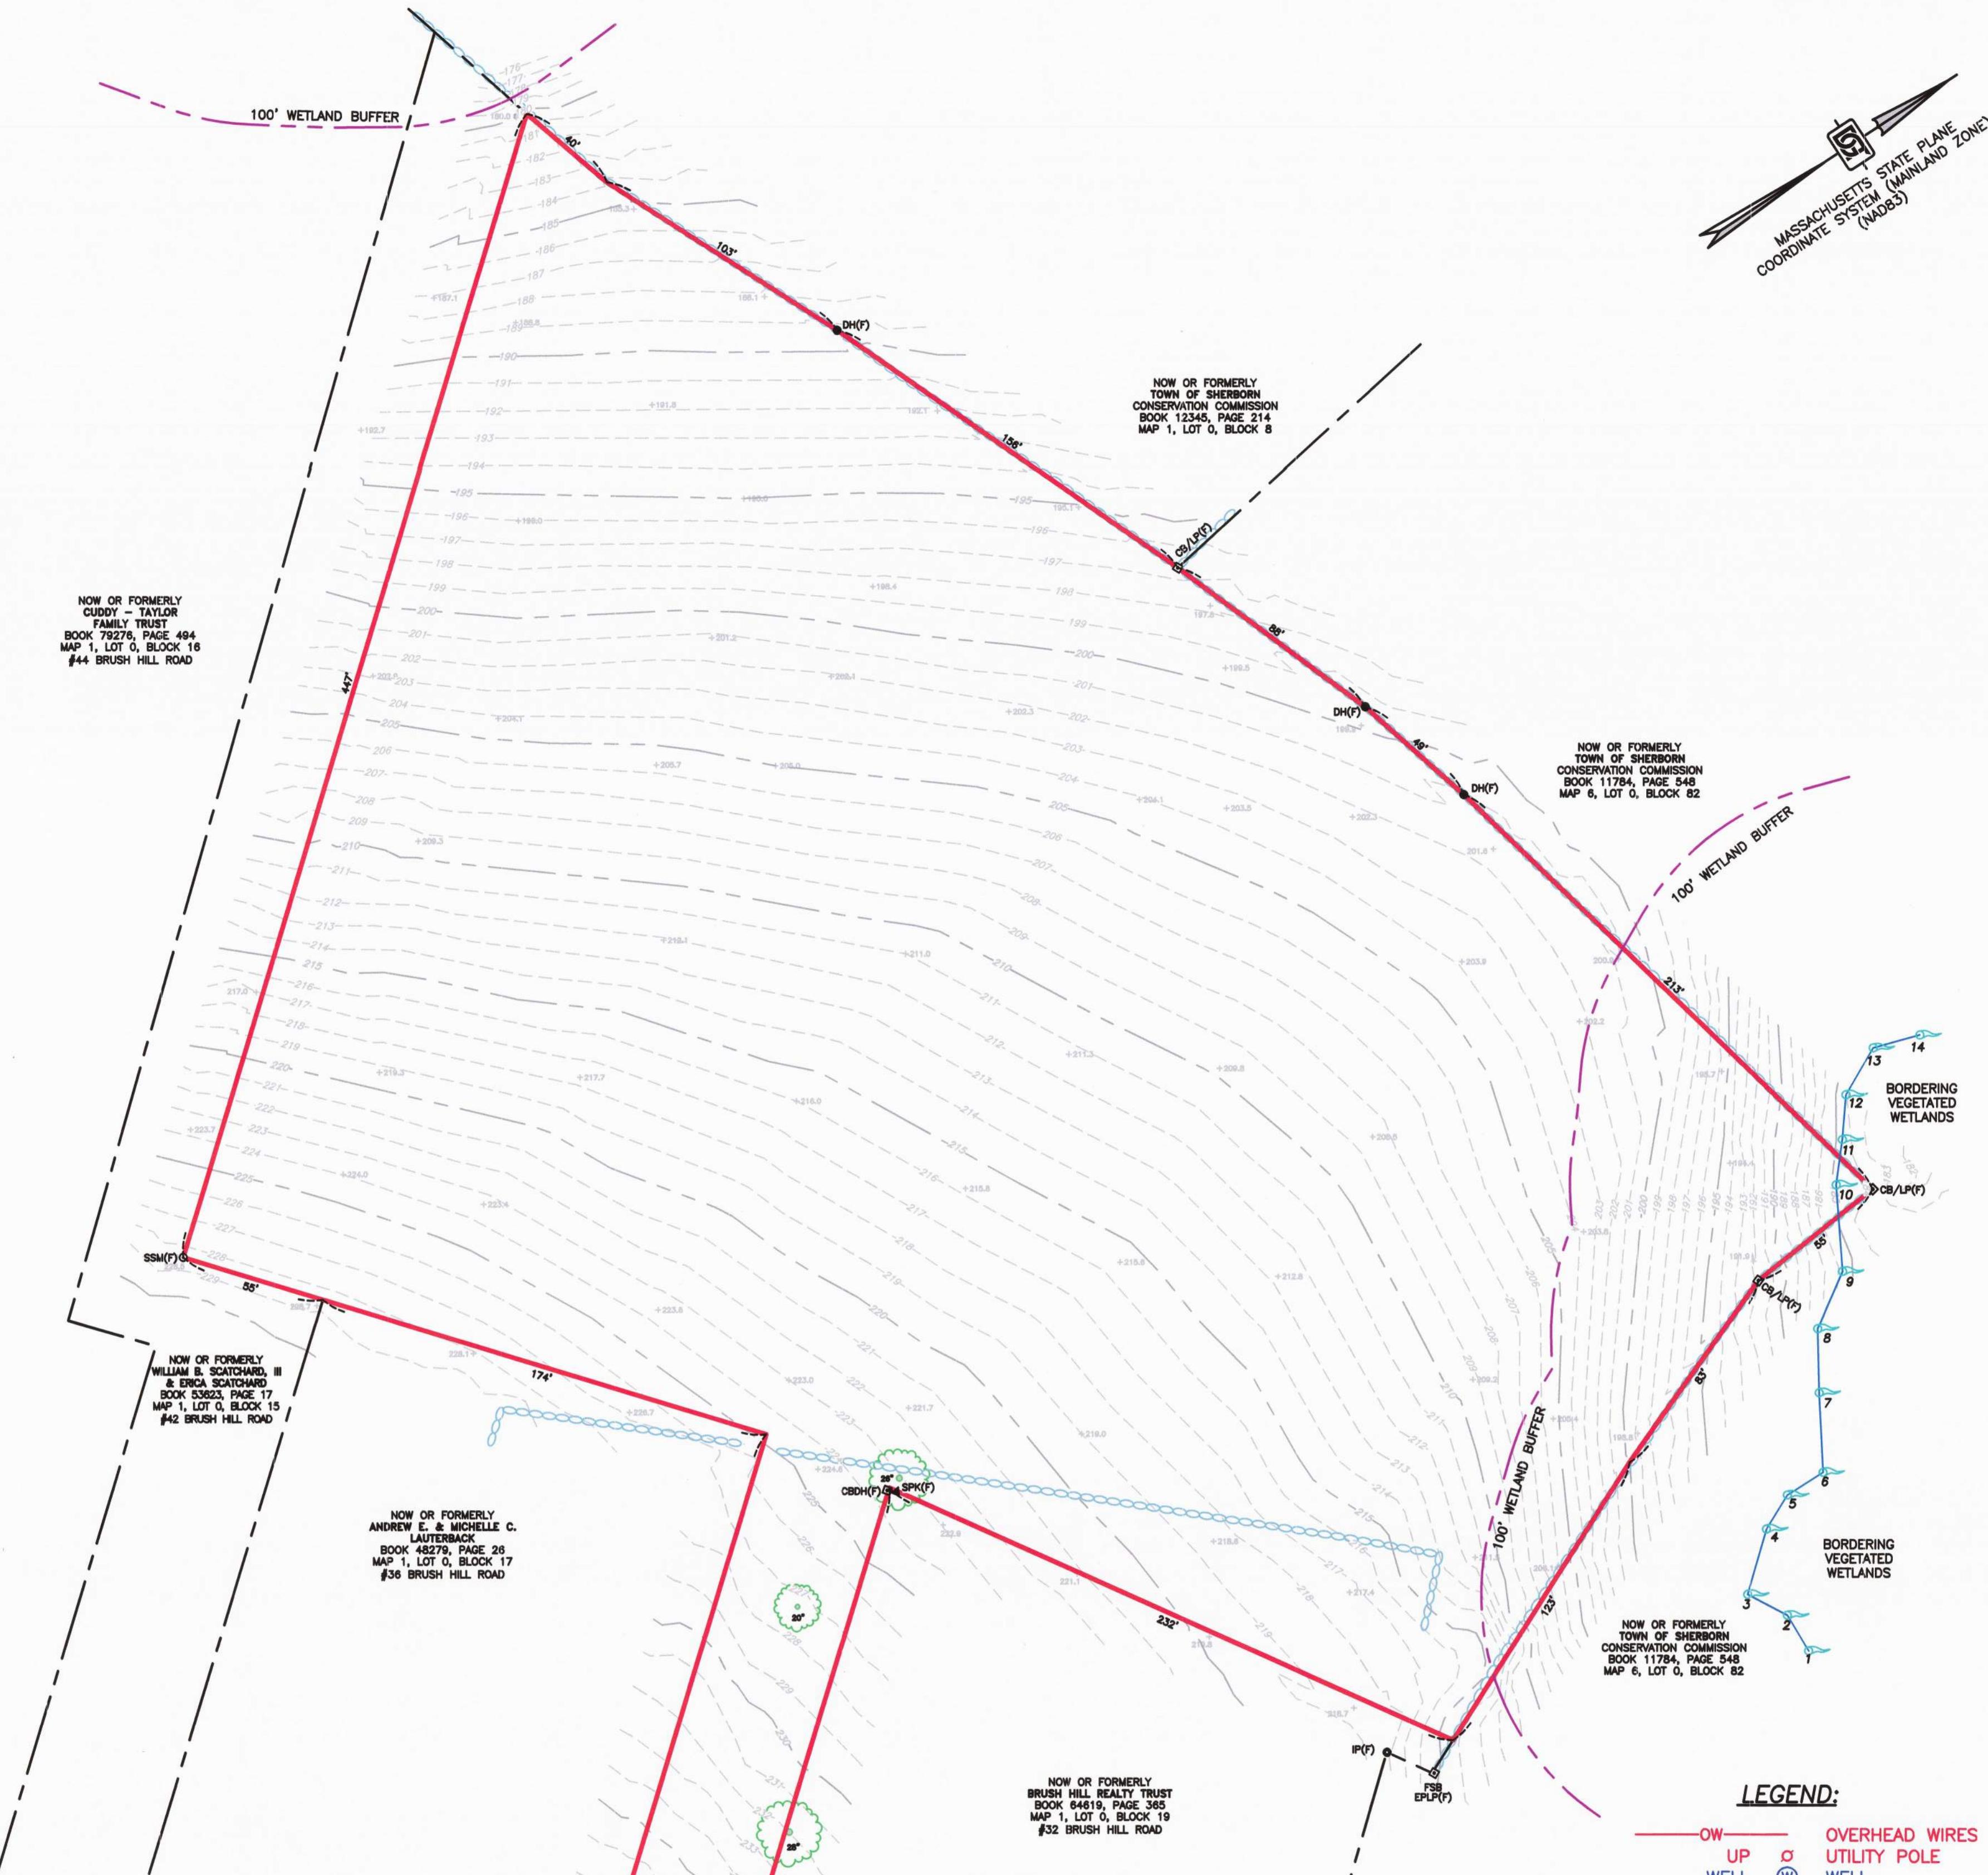
SITE DETAILS - 05

SHEET: 17 OF 17	C-17
PROJECT NO.: F-25889	

OUTLET CONTROL STRUCTURE DETAILS for OCS #1, #2, #3, #4 and #6

(NO SCALE)



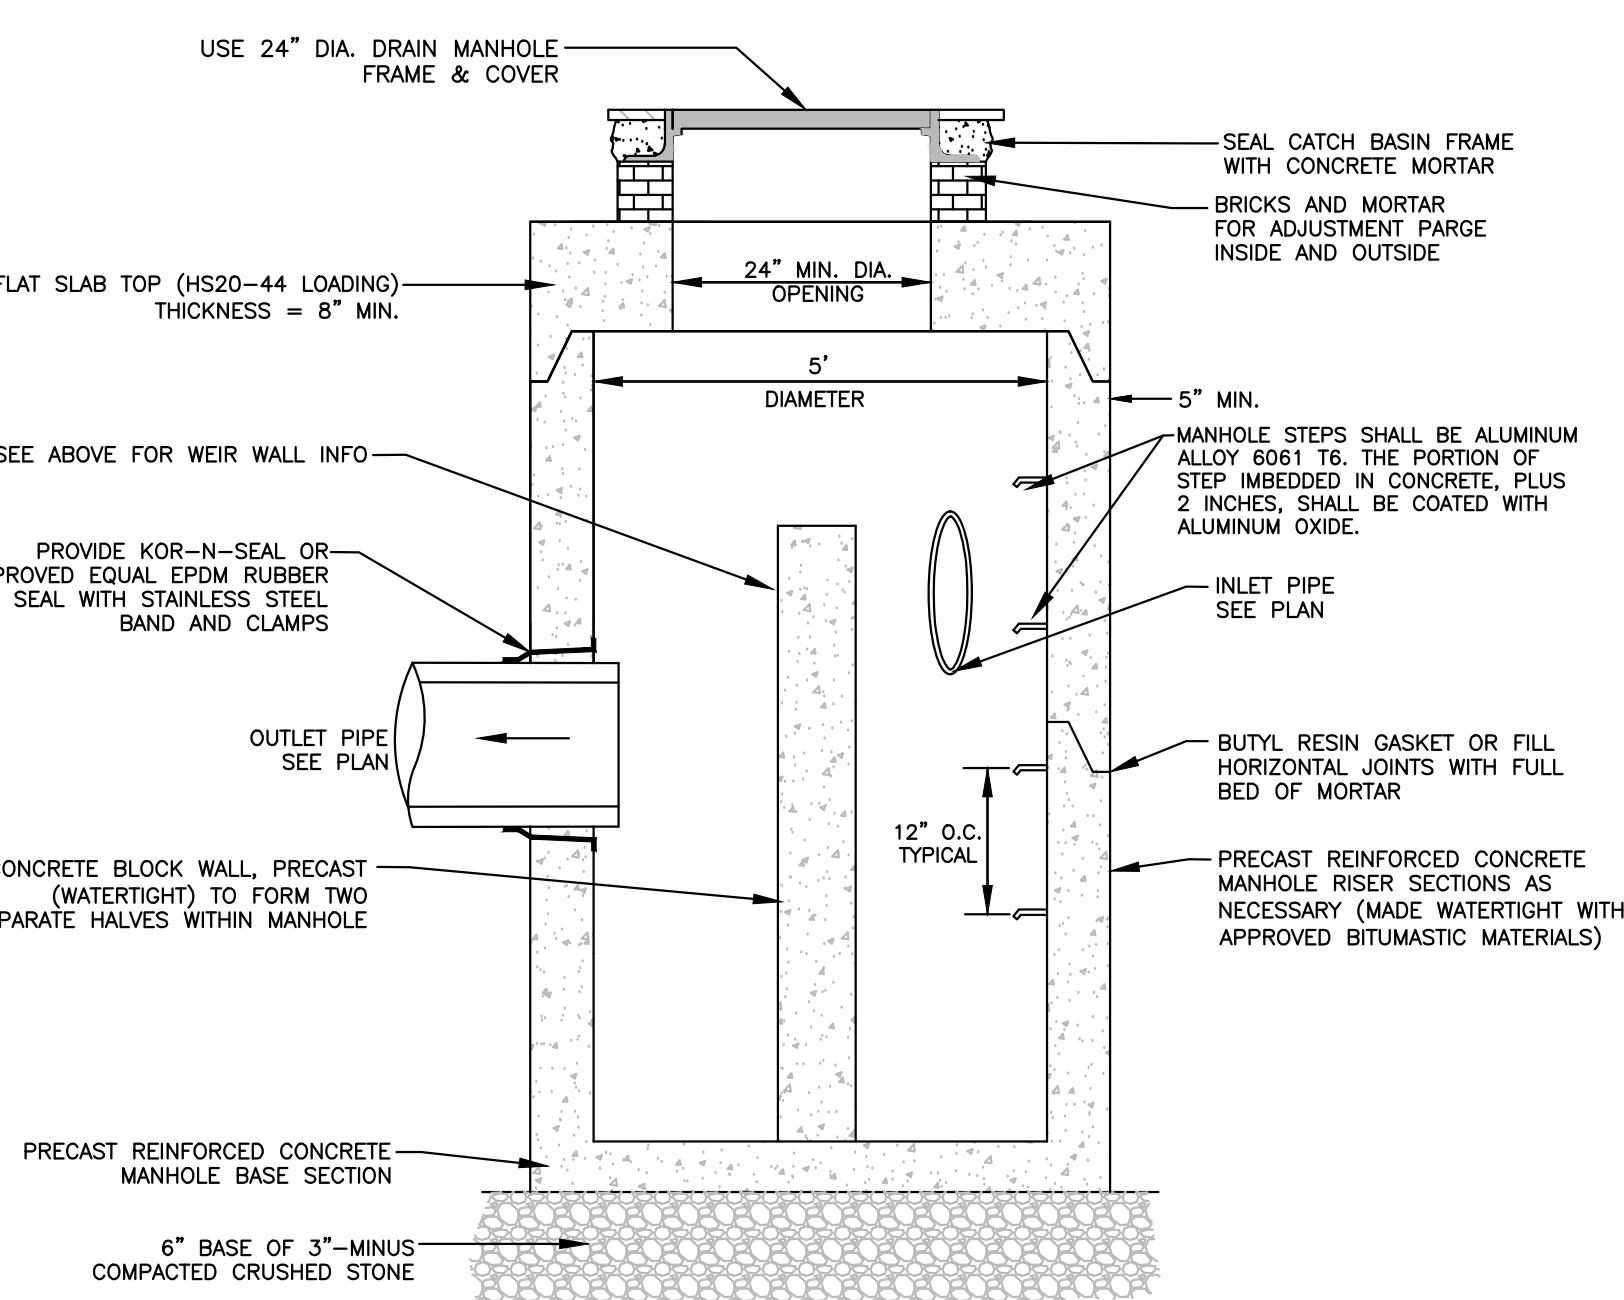

LEGEND:

OW	OVERHEAD WIRES
UP	UTILITY POLE
WELL	WELL
W	WELL

SURVEY MONUMENTS:

CBDH	CONCRETE BOUND DRILL HOLE
CB/LP	CONCRETE BOUND NO DRILL HOLE
DH	DRILL HOLE
EPPL	ESCUCHON PIN IN LEAD PLUG
IP	IRON PIPE
FSB	FIELD STONE BOUND DRILL HOLE
SPK	SPIKE
SSM	STEEL SURVEY MARKER
(F)	FOUND

GENERAL NOTES:

- FIELD SURVEY PERFORMED IN SEPTEMBER AND OCTOBER OF 2023.
- ELEVATIONS REFER TO NORTH AMERICAN VERTICAL DATUM OF 1988 (NAVD88). ELEVATIONS WERE ESTABLISHED BY RTK GPS OBSERVATIONS UTILIZING GEOD 2018.
- THIS PLAN IS PREPARED FOR OUR CLIENT USE ONLY FOR THE SPECIFIC PURPOSE OF OBTAINING PERMITS AND LOCAL APPROVALS, AND IS NOT TO BE USED OR RELIED UPON AS A CONSTRUCTION DOCUMENT OR ANY OTHER USE BY OTHERS WITHOUT THE WRITTEN CONSENT OF DGT.
- RECORD OWNER IS FENIX PARTNERS BRUSH HILL, LLC. SEE DEED BOOK 81892 PAGE 265.
- SEE SHERBORN ASSESSORS PARCEL 1-0-18
- PARCEL FALLS WITHIN ZONING DISTRICT RESIDENCE B "RB."
- SEE MIDDLESEX SOUTH REGISTRY OF DEEDS FOR RECORD DOCUMENTS.
- LEGAL STATUS OF EASEMENTS, WAYS, AND RESTRICTIONS NOT DETERMINED BY THIS SURVEY.
- PROPERTY LINES SHOWN HEREON ARE APPROXIMATE.
- ABUTTING BUILDING OUTLINES ARE TAKEN FROM MASSGIS.
- WETLAND FLAG LOCATIONS ARE TAKEN FROM A PLAN TITLED "PLAN OF LAND" DATED AUGUST 8, 2023 BY SAMIOTES CONSULTANTS, INC.



I HEREBY CERTIFY THAT:

THIS PLAN IS BASED ON AN ON-THE-GROUND SURVEY AND PRESENTS THE FACTS AS FOUND AT THE TIME OF THE SURVEY.

Peter A. Lothian
PROFESSIONAL LAND SURVEYOR

6/27/2024
DATE

SCALE: 1" = 40'

RESEARCH: DGT	TOPOGRAPHIC PLAN OF LAND IN SHERBORN, MASSACHUSETTS MIDDLESEX COUNTY - SOUTH DISTRICT	34 BRUSH HILL ROAD SHERBORN, MA 01770	CALCULATIONS: DGT	PREPARED BY: DGT Associates Surveying & Engineering Framingham • Boston • Worcester Mystic, CT 1071 Worcester Road, Framingham, MA 01701 508-879-0030 www.DGTassociates.com	DATE: 06-27-2024
FIELD: RAM/JNT			DRAFTING: RAM		PROJECT NO.: F-25889_00 EC
SCALE: 1"=40'			CHECK: PAL		CRD FILE: F-25889_MASTER
©2024 DGT ASSOCIATES INC.			PROJ. MANAGER P. LOTHIAN, PLS		SHEET 1 OF 1